



LOCALITY PLAN
N.T.S.

LGA WOLLONDILLY COUNCIL
LOT 11 & 2, DP 1262205 & 1262034

CLIENT:





Transport
for NSW

DRAWING LIST

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GENERAL	
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SEDIMENT & EROSION CONTROL	
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STATION ST MENANGLE
PEDESTRIAN BRIDGE CROSSING

GENERAL NOTES

GENERAL

- G1.

ALL WORK TO BE CARRIED OUT IN ACCORDANCE WITH WOLLONDILLY SHIRE COUNCIL'S ENGINEERING DESIGN, ENGINEERING CONSTRUCTION SPECIFICATION AND TO THE REQUIREMENTS OF THE PRINCIPAL CERTIFYING AUTHORITY/ ROADS AUTHORITY.
- G2.

INSPECTIONS BY PRINCIPAL CERTIFYING AUTHORITY/ ROADS AUTHORITY SHALL BE REQUESTED AT THE FOLLOWING STAGES AND THE WORKS APPROVED PRIOR TO THE CONTINUANCE OF ANY WORK:
(a) FOLLOWING THE INSTALLATION OF EROSION AND SEDIMENT CONTROL STRUCTURES/MEASURES

(b) FINAL INSPECTIONS AFTER ALL WORKS ARE COMPLETED AND "WORK AS EXECUTED" PLANS HAVE BEEN SUBMITTED TO COUNCIL.
- G5.

NO TREES TO BE REMOVED UNLESS APPROVAL IS GRANTED BY COUNCILS LANDSCAPE COMPLIANCE OFFICER/DA CONSENT.
- G6.

MAKE SMOOTH JUNCTIONS WITH EXISTING WORKS
- G7.

NO WORK TO BE CARRIED OUT ON COUNCIL PROPERTY OR ADJOINING PROPERTIES WITHOUT THE WRITTEN PERMISSION FROM THE OWNER/S.
- G8.

VEHICULAR ACCESS AND ALL UTILITIES/SERVICES ARE TO BE MAINTAINED AT ALL TIMES TO ADJOINING PROPERTIES AFFECTED BY CONSTRUCTION.
- G9.

ALL RUBBISH, BUILDINGS, SHEDS, AND FENCES ARE TO BE REMOVED TO THE SATISFACTION OF COUNCILS ENGINEER/SUPERINTENDENT.
- G10.

COUNCIL ENGINEERS HAVE DISCRETION TO VARY, AS CONSIDERED NECESSARY, THE ENGINEERING REQUIREMENTS IN RESPECT OF PARTICULAR SUBDIVISION OR DEVELOPMENT HAVING REGARD TO THE SITE CONTEXT
- G11.

ALL LEVELS REFERENCED ARE AHD.
- G12.

ALL WORK TO BE CARRIED OUT IN ACCORDANCE WITH WOLLONDILLY SHIRE COUNCIL SUBDIVISION & ENGINEERING STANDARD AND HAVE REGARD FOR TINSW REQUIREMENTS
- 'WOLLONDILLY SHIRE COUNCIL CONSTRUCTION SPECIFICATION 2016'
- 'WOLLONDILLY SHIRE COUNCIL DESIGN SPECIFICATION 2016'
- 'WOLLONDILLY SHIRE COUNCIL STANDARD DRAWINGS 2016'
- G.13.

ALL WORK WITHIN RAIL CORRIDOR TO BE CARRIED OUT IN ACCORDANCE WITH ARTC REQUIREMENTS INCLUDING ARTC'S ENVIRONMENTAL PROTECTION LICENCE.

EARTHWORKS

1.

EARTHWORKS ARE TO BE CARRIED OUT TO THE SATISFACTION OF THE PRINCIPAL CERTIFYING AUTHORITY/ ROADS AUTHORITY. UNSUITABLE MATERIALS ARE TO BE REMOVED FROM ROADS AND LOTS PRIOR TO FILLING. THE CONTRACTOR IS TO ARRANGE AND MAKE AVAILABLE COMPACTION TESTING RESULTS FOR ALL AREAS THAT CONTAIN FILL IN EXCESS OF 200mm.
2.

COMPACTION OF EARTHWORKS SHALL CONTINUE UNTIL A DRY DENSITY RATIO OF 95% FOR SITE FILLING AND 100% FOR ROAD PAVEMENT SUBGRADES HAS BEEN ACHIEVED IN ACCORDANCE WITH TEST METHOD AS1289.5.3.1 OR AS1289.5.1.1.
3.

THE CONTROL TESTING OF EARTHWORKS SHALL BE IN ACCORDANCE WITH THE GUIDELINES IN AS3798 "GUIDELINES ON EARTHWORKS FOR COMMERCIAL AND RESIDENTIAL DEVELOPMENTS". WHERE IT IS PROPOSED TO USE TEST METHOD AS1298.5.8.2 TO DETERMINE THE FIELD DENSITY, A SAND REPLACEMENT METHOD SHALL BE USED TO CONFIRM THE RESULTS.
4.

THE SUBDIVISIONAL GEOTECH ACCREDITED CERTIFIER, SHALL HAVE A LEVEL1 RESPONSIBILITY FOR ALL FILLING AS DEFINED IN APPENDIX B AS3798 'GUIDELINES ON EARTHWORKS FOR COMMERCIAL AND RESIDENTIAL DEVELOPMENTS' AND AT THE END OF THE WORKS SHALL CONFIRM THE EARTHWORKS COMPLY WITH THE REQUIREMENTS OF THE SPECIFICATION AND DRAWINGS BY WRITTEN NOTIFICATION.
5.

IN AREAS TO BE FILLED WHERE THE SLOPE OF THE NATURAL SURFACE EXCEEDS 1(V):4(H), BENCHES ARE TO BE CUT TO PREVENT SLIPPING OF THE PLACED FILL MATERIAL AS REQUIRED BY THE COUNCIL
6.

ALL BATTERS ARE TO BE SCARIFIED TO A DEPTH OF 50mm TO ASSIST THE ADHESION OF TOP SOIL TO BATTER FACE.
7.

PROVIDE MINIMUM 150mm AND MAXIMUM 300mm TOPSOIL WITHIN FOOTPATHS, FILLED AREAS AND ALL OTHER AREAS DISTURBED DURING CONSTRUCTION. TOPSOILED AREAS TO BE STABILISED WITH APPROVED VEGETATION A MAXIMUM OF 2 DAYS AFTER TOPSOILING AND ARE TO BE WATERED TO ENSURE GERMINATION.
8.

THE CONTRACTOR SHALL CONTROL SEDIMENTATION, EROSION AND POLLUTION DURING CONSTRUCTION IN ACCORDANCE WITH THE REQUIREMENTS OF THE CURRENT EDITION OF 'MANAGING URBAN STORMWATER: SOILS AND CONSTRUCTION' PROVIDED BY URBAN GROWTH.
9.

EARTHWORKS TO BE SUPERVISED BY A GEOTECHNICAL ENGINEER

CALIBRE GENERAL

- CG1.

SURVEY SOURCED FROM:
-SURVEYOR: 'ADW JOHNSON' D.T.M. & BOUNDARY: 300058-DET-004-A.dwg SURVEY DATED 27 APRIL 2021
-SURVEYOR: 'ALS' : 204569-US-Menangle - DWG: LOT 202 DP590247 MENANGLE - DATED MARCH 2021
-SURVEYOR: 'ALS' : 204724-US-Menangle - DWG: STATION STREET MENANGLE - DATED APRIL 2021
NOTE: TREES SHOWN ARE INDICATIVE ONLY AND ARE A COMBINATION OF THE ABOVE SURVEY AND AERIAL IMAGING. AERIAL IMAGE SOURCED FROM NEARMAP DATED 16/05/2021. TREES ARE TO BE VERIFIED BY PROJECT ARBORIST.
- CG2.

CONTRACTOR IS TO ENSURE THAT ALL WORKS ASSOCIATED WITH PROPERTY BOUNDARIES ARE TO BE SET OUT OR VERIFIED BY A REGISTERED SURVEYOR

ROADWORKS

- R1.

SUBGRADES AND SUB BASES ARE TO BE COMPACTED IN ACCORDANCE WITH COUNCIL'S CONSTRUCTION SPECIFICATION.
- R2.

SUBSOIL DRAINS TO BE PROVIDED ON BOTH SIDES OF ROADS (EXCEPT WHERE THERE IS STORMWATER DRAINAGE).
- R3.

LIPLESS PERAMBULATOR CROSSINGS ARE TO BE PROVIDED IN ALL KERB RETURNS AND WHERE REQUIRED BY COUNCIL.
- R4.

SERVICE CONDUITS TO BE PLACED AS DIRECTED BY ALL PUBLIC UTILITY AUTHORITIES INCLUDING ENDEAVOUR ENERGY, TELSTRA AND SYDNEY WATER
- R5.

PROPOSED UTILITIES AND SERVICES CROSSING EXISTING ROADS SHALL BE PROVIDED FOR USING A TRENCHLESS TECHNIQUE SO AS NOT TO DAMAGE THE EXISTING SURFACE. ALL SERVICE CONDUITS UNDER ROADS MUST BE LAID TO A MINIMUM DEPTH OF 750mm.
- R6.

CONCRETE FOOTPATH CONSTRUCTION IS TO FOLLOW COMPLETION OF UTILITY/SERVICES AND SURROUNDING DWELLINGS.
- R7.

ALL TEMPORARY ROADS MUST BE TEMPORARILY SEALED WITH A SINGLE COAT FLUSH SEAL.
- R8.

REFER TO PAVEMENT PLAN SHEET 601 FOR ALL PAVEMENT DETAILS.
- R9.

SIGNPOSTING AND LINE MARKING SHALL CONFORM TO AS1742.2 'TRAFFIC CONTROL DEVICES FOR GENERAL USE'. RAISED RETRO-REFLECTIVE PAVEMENT MARKERS TO CONFORM TO AS1906 'RETRO-REFLECTIVE MATERIALS AND DEVICES FOR ROAD TRAFFIC CONTROL PURPOSES'. ALL APRONS AND KERB FACE ON CENTRAL ISLANDS OF ROUNDABOUTS AND ALL OTHER ISLANDS TO BE DELINEATED BY REFLECTIVE WHITE MARKING. INSTALLATION SHALL OCCUR IN ACCORDANCE WITH THE PLAN APPROVED BY THE LOCAL TRAFFIC COMMITTEE.
- R10

STREET SIGNS TO COUNCIL STANDARD MUST BE INSTALLED BY THE CONTRACTOR.
- R11.

STORMWATER PIPES IN ROAD RESERVE SHOULD BE A MINIMUM CLASS 3 RCP WITH A MINIMUM PIPE SIZE OF Ø375

STORMWATER

- S1.

ALL PIPES TO BE SPIGOT AND SOCKET, RUBBER RING JOINTED.
- S2.

ALL LONGITUDINAL PIPELINES IN ROADS MUST BE LOCATED UNDER KERB AND GUTTER AND BE BACKFILLED WITH APPROVED GRANULAR MATERIAL UNLESS OTHERWISE APPROVED BY THE COUNCIL ENGINEER.
- S3.

DRAINAGE LINES MUST BE BACKFILLED WITH APPROVED GRANULAR MATERIAL IN TRAFFICABLE AREAS. THREE (3) METRES OF SUBSOIL DRAINAGE WRAPPED IN GEOTEXTILE STOCKING MUST BE PROVIDED TO ALL DOWNSTREAM PITS.
- S4.

ALL GULLY PITS TO COUNCIL'S STANDARD AND LINTELS CENTRALLY PLACED AT SAG PITS.
- S5.

ALL PITS MUST BE BENCHED AND STREAMLINED. PROVIDE SL72 REINFORCEMENT AND GALVANISED STEP IRONS IN ALL PITS OVER 1.2-METRES DEEP AS MEASURED FROM THE TOP OF GRATE TO THE INVERT OF THE PIT.
- S6.

CONCRETE IS TO HAVE MINIMUM COMPRESSIVE STRENGTH OF 32MPA AT 28-DAYS UNLESS OTHERWISE APPROVED BY THE COUNCIL ENGINEER.
- S7.

ALL INTER-ALLOTMENT DRAINAGE MUST HAVE A MINIMUM PIPE DIAMETER OF 150mm AND A MINIMUM GRADE OF 1% UNLESS OTHERWISE APPROVED BY THE COUNCIL ENGINEER.
- S8.

ALL INTER-ALLOTMENT DRAINAGE LINES MUST BE LAID CENTRALLY WITHIN DRAINAGE EASEMENTS. INSPECTION PITS MUST BE PROVIDED AT ALL CHANGES OF GRADE AND DIRECTION.
- S9.

INTER-ALLOTMENT DRAINAGE LINES MUST BE INSTALLED AFTER SYDNEY WATER SEWERAGE LINES HAVE BEEN INSTALLED WHERE SEWER IS PROPOSED ADJACENT TO INTER-ALLOTMENT DRAINAGE LINES.
- S10.

1% AEP OVERLAND FLOW PATHS MUST BE FORMED AND SHOWN ON 'WORKS AS EXECUTED' DRAWINGS.
- S11.

ALL PLANS (BOTH DESIGN AND WAE) ARE TO CLEARLY DELINEATE THE EXTENT/LOCATION OF FLOOD LINES INCLUDING THE 5% AEP, 1% AEP AND PMF.
- S12.

ADEQUATE PROVISION IS TO BE MADE TO PREVENT SCOURING AND SEDIMENTATION FOR ALL DRAINAGE WORKS IN ACCORDANCE WITH COUNCIL'S REQUIREMENTS.
- S13.

PIT LINTELS ARE TO BE STENCILLED WITH APPLICABLE DISTINCTION STENCIL AVAILABLE FROM COUNCIL.
- S14.

CATCH DRAINS MUST BE CONSTRUCTED AS REQUIRED BY THE APPROVED PLANS OR THE PRINCIPAL CERTIFYING AUTHORITY.
- S15.



SOIL AND WATER MANAGEMENT PLANS ARE TO BE PREPARED FOR ALL DISTURBED SITES AND ADHERED TO AT ALL TIMES DURING THE CONSTRUCTION AND MAINTENANCE PERIODS.


LEGEND

DESCRIPTION	PROPOSED	EXISTING	FUTURE
STORMWATER PIPELINE			
STORMWATER DRAINAGE PITS			
DRAINAGE LINE No. 3 DRAINAGE PIT No. 10			
CONCRETE HEADWALL			
SUBSOIL DRAIN			
150mm KERB AND GUTTER			
450mm MODIFIED KERB AND GUTTER			
PEDESTRIAN RAMP			
EDGE OF BITUMEN			
ROAD PAVEMENT			
BENCHMARK			
BATTERS			
CONCRETE PATHWAY			
CONTOURS			
SITE REGRADING AREA			
SERVICE LINES SEWER, GAS, WATER, ELECTRICITY, RAIL WORKS SERVICE			
COMMUNICATION LINES TELSTRA, FIBRE OPTIC, NBN			
OVER HEAD LINES AND POLES			
SERVICE PITS TELECOM PIT, ACCESS CHAMBER, HYDRANT, STOP VALVE, AIR VALVE			
LIMIT OF ROAD CONSTRUCTION			
STAGE BOUNDARY			
LOT BOUNDARY			
EXISTING EASEMENT			
EXISTING BARRIER			
FENCE POST AND RAIL FENCE ARTC BOUNDARY FENCE			
LOT NUMBERS			
TREES TO RETAIN WITHIN SITE TREES TO REMOVED WITHIN SITE			

DIGITAL MODELS CREATED BY CALIBRE UNDER THIS COMMISSION ARE CREATED FOR THE PURPOSE OF THE PREPARATION OF DRAWINGS AND ESTIMATES OF QUANTITIES. INFORMATION CONTAINED IN THE DRAWINGS TAKES PRECEDENCE OVER THE DIGITAL MODEL UPON WHICH IT WAS BASED. USE OF DIGITAL MODELS, CREATED BY CALIBRE, BY OTHER PARTIES TO SET OUT WORKS OR FOR OTHER REASONS IS DONE ENTIRELY AT THE RISK OF THE PARTY SO USING THE DIGITAL MODEL

FILE: H:\1717-2020S - STATION ST MENANGLE - UD06 - MODEL\MUTOGAD\CONCEPTS\TRANSPORT\DESIGN\1717-2020S-02-PED-10-SWC-001.DWG LAST SAVED BY ADAM BATH

DESIGN DRAWN CHECK APPD. DATE							STATUS	SCALE	CLIENT	PROJECT	DRAWING TITLE	
AMENDMENT DETAILS							FOR REVIEW OF ENVIRONMENTAL FACTORS (PART 5)				STATION ST MENANGLE PEDESTRIAN BRIDGE CROSSING	GENERAL NOTES & LEGEND
01 AV LH CK EF 10/06/2021 ISSUED FOR CONSTRUCTION CERTIFICATE							AUTHORISED FOR ISSUE:					
02 AV AB CK EF 01/07/2021 ISSUED FOR CONSTRUCTION CERTIFICATE							BY: SINA ARBABZADEH	SIGN: <i>Sina Arbabzadeh</i>				
03 AV AV CK EF 18/08/2022 ISSUED FOR CONSTRUCTION CERTIFICATE							MEng (Civil) MIEAust CPEng NER	DATE: <i>25/05/2023</i>				
04 RT SS CK EF 07/10/2022 ISSUED FOR CONSTRUCTION CERTIFICATE												
05 RT AB GM SA 25/05/2023 ISSUED FOR REF APPROVAL												

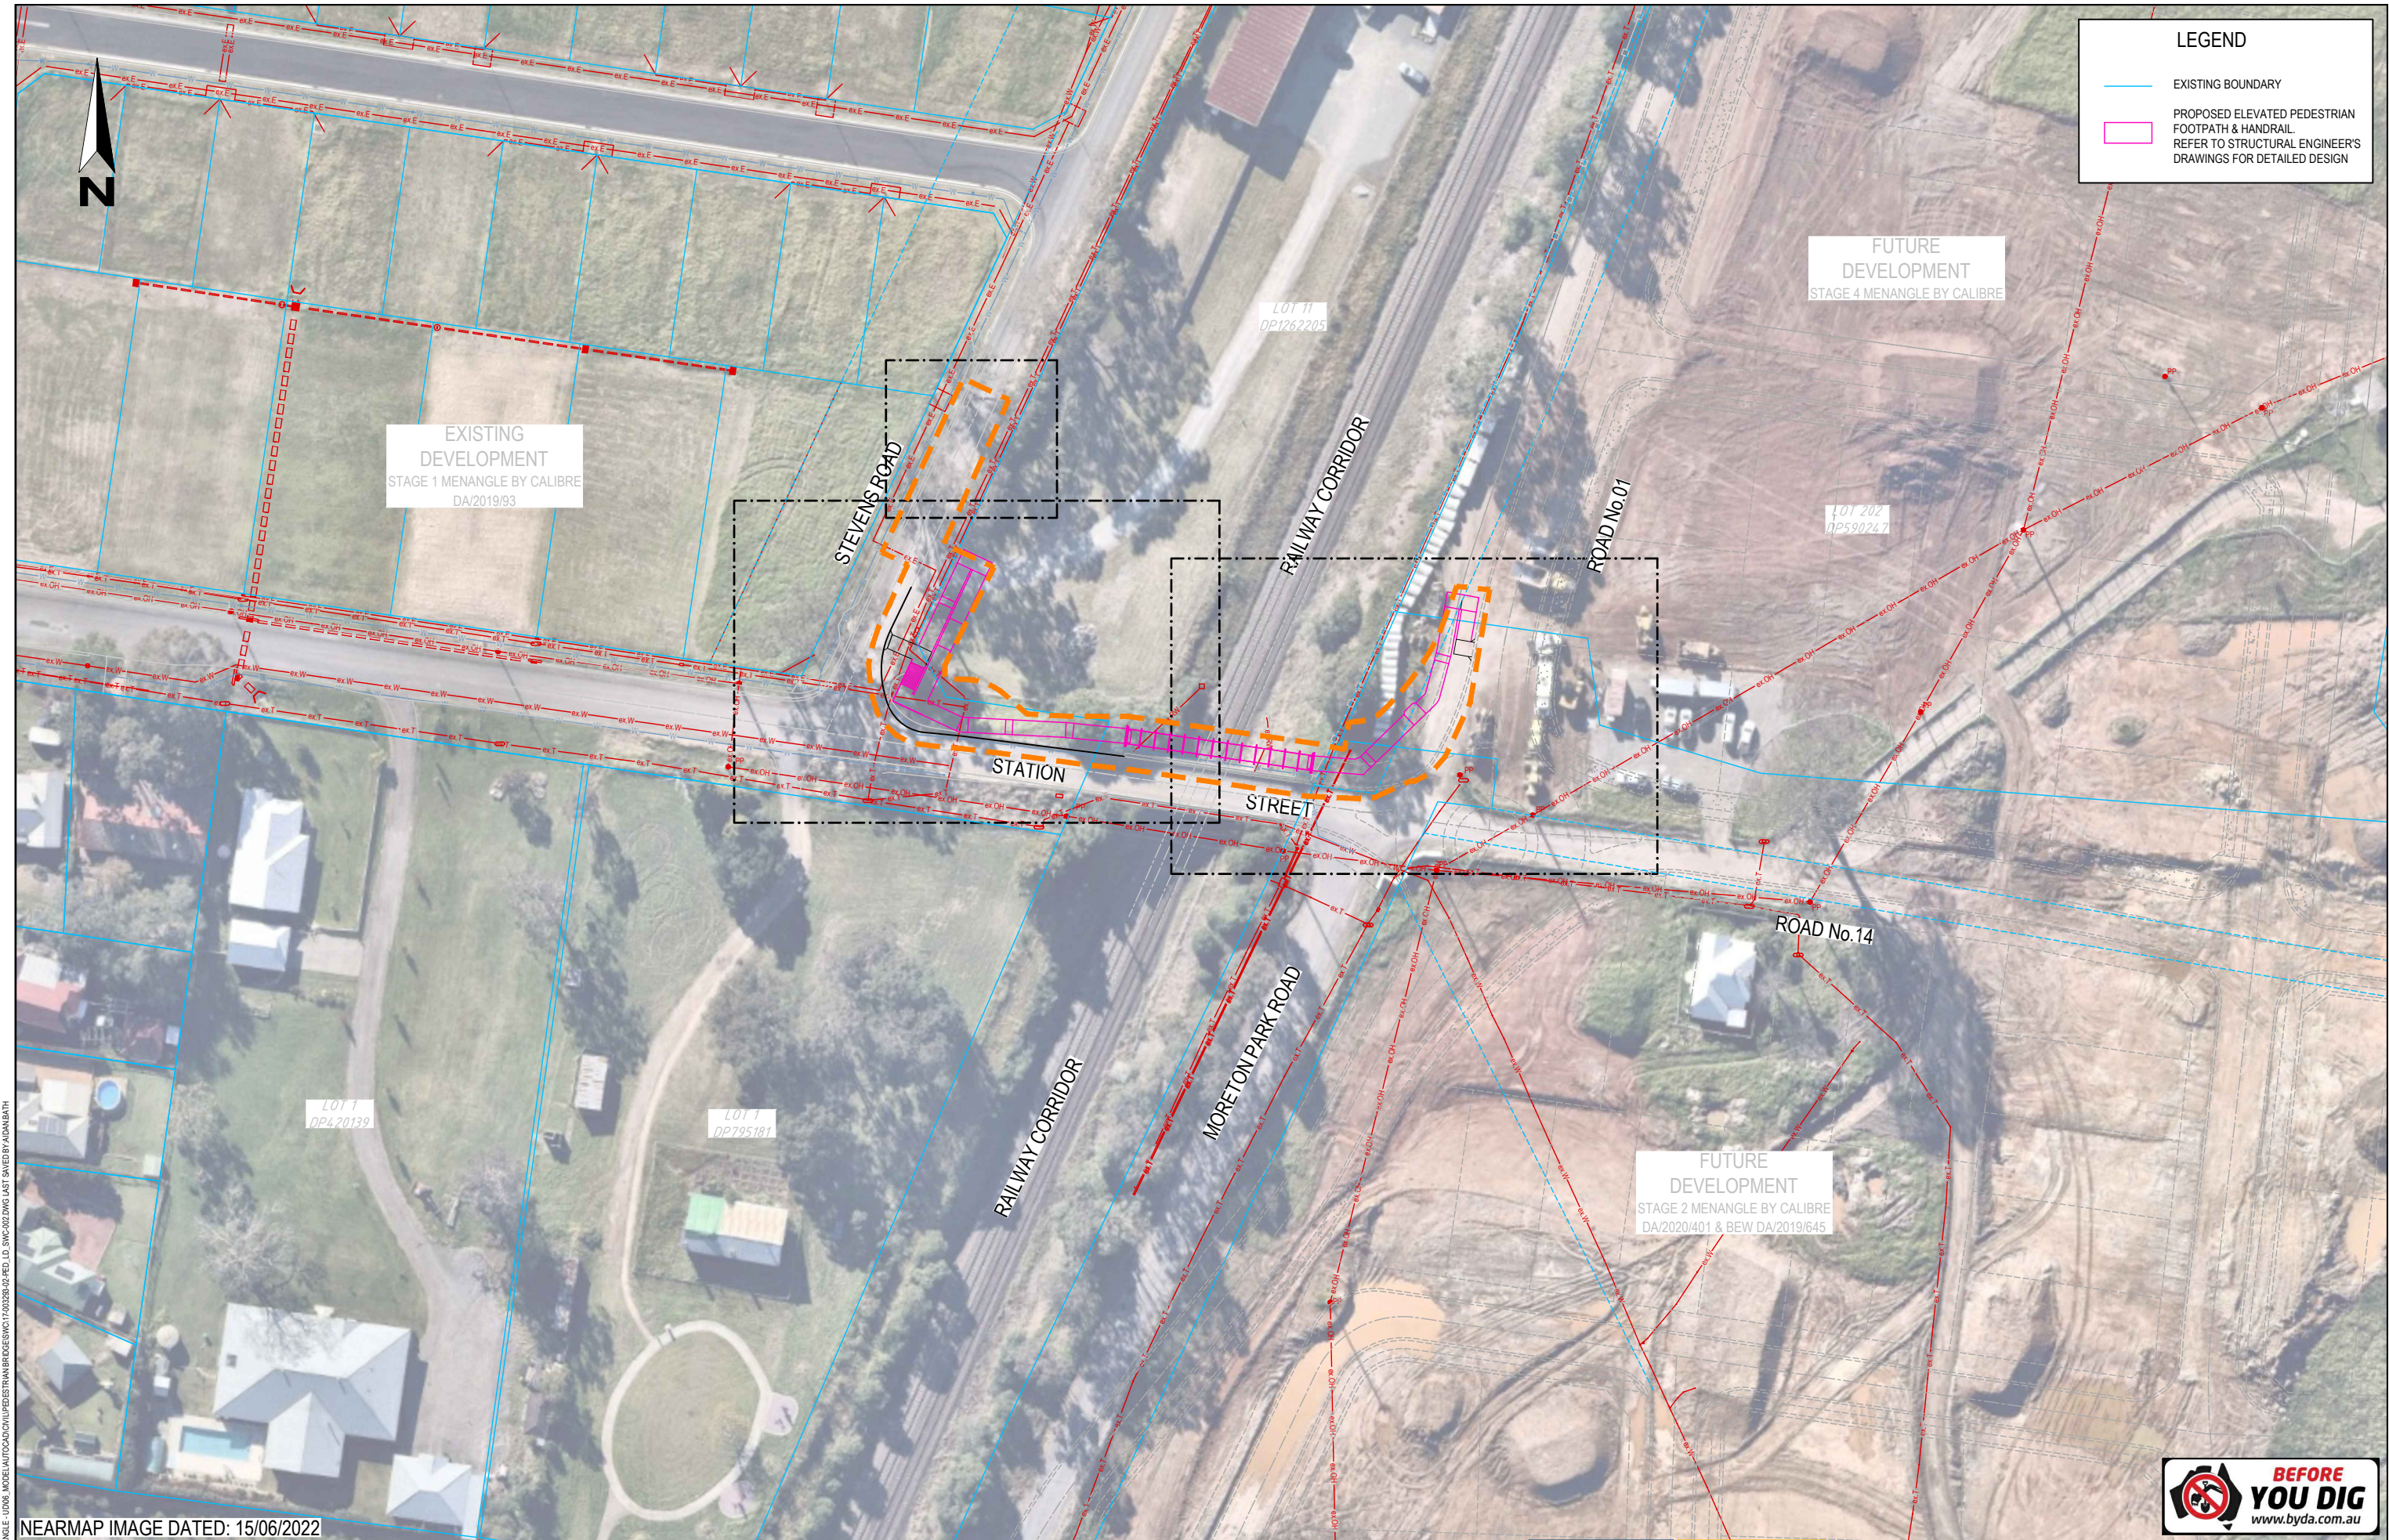

LEGEND

EXISTING BOUNDARY

PROPOSED ELEVATED PEDESTRIAN FOOTPATH & HANDRAIL. REFER TO STRUCTURAL ENGINEER'S DRAWINGS FOR DETAILED DESIGN

FUTURE DEVELOPMENT
STAGE 4 MENANGLE BY CALIBRE

EXISTING DEVELOPMENT
STAGE 1 MENANGLE BY CALIBRE
DA/2019/93

LOT 202
DP590247

LOT 11
DP1262205

LOT 1
DP420139

LOT 1
DP795181

FUTURE DEVELOPMENT
STAGE 2 MENANGLE BY CALIBRE
DA/2020/401 & BEW DA/2019/645



NEARMAP IMAGE DATED: 15/06/2022

REV	DATE	AMENDMENT DETAILS			
		DESIGN	DRAWN	CHECK	APPROVED
01	25/02/2021	AV	AB/JS	CK	EF
02	10/06/2021	AV	LH	CK	EF
03	01/07/2021	AV	AB	CK	EF
04	18/08/2022	AV	AV	CK	EF
05	07/10/2022	RT	SS	CK	EF
06	25/05/2023	RT	AB	GM	SA

STATUS

FOR REVIEW OF ENVIRONMENTAL FACTORS (PART 5)

AUTHORISED FOR ISSUE:

BY: SINA ARBAZADEH
MEng (Civil) MIEAust CPEng NER

SIGN: *Sina Arbazadeh*
25/05/2023

DATE:

SCALE

0 5 10 15 20 25 30 35 40

SCALE 1:500 (A1)

SCALE 1:1000 (A3)

CLIENT

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PROJECT

STATION ST MENANGLE
PEDESTRIAN BRIDGE CROSSING

DISCLAIMER
ALL DIMENSIONS TO BE CHECKED ON SITE BY CONTRACTOR PRIOR TO CONSTRUCTION. USE WRITTEN DIMENSIONS ONLY, DO NOT SCALE. NOT FOR CONSTRUCTION UNLESS STAMPED BY CERTIFYING AUTHORITY

DRAWING TITLE



GENERAL ARRANGEMENT PLAN

PROJECT No. 17-003293.002.PED

DRAWING No. 002

MILESTONE REF

REVISION 05

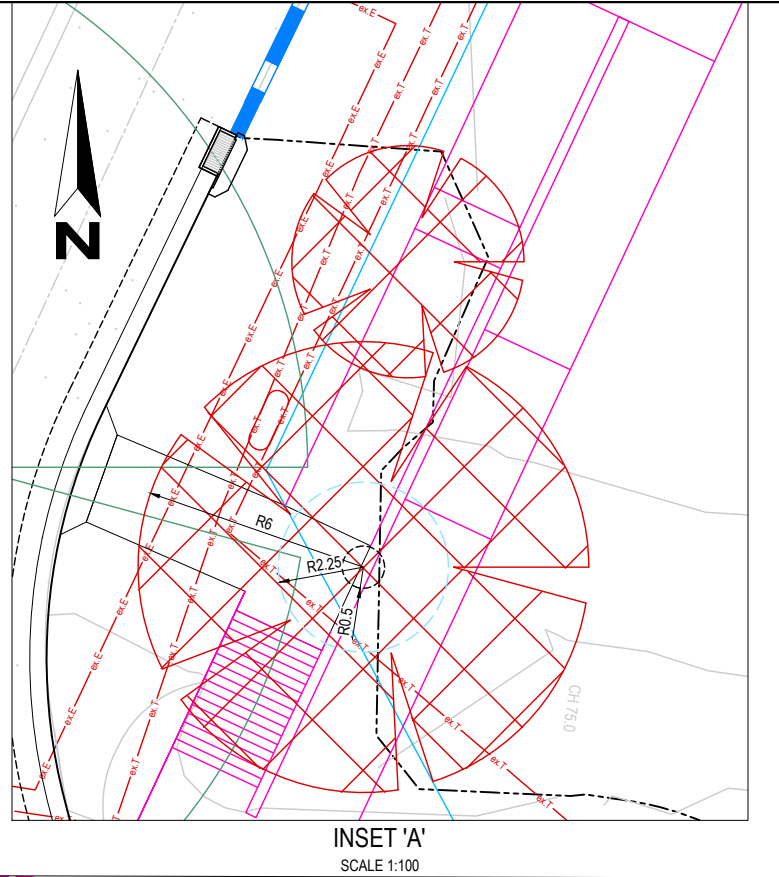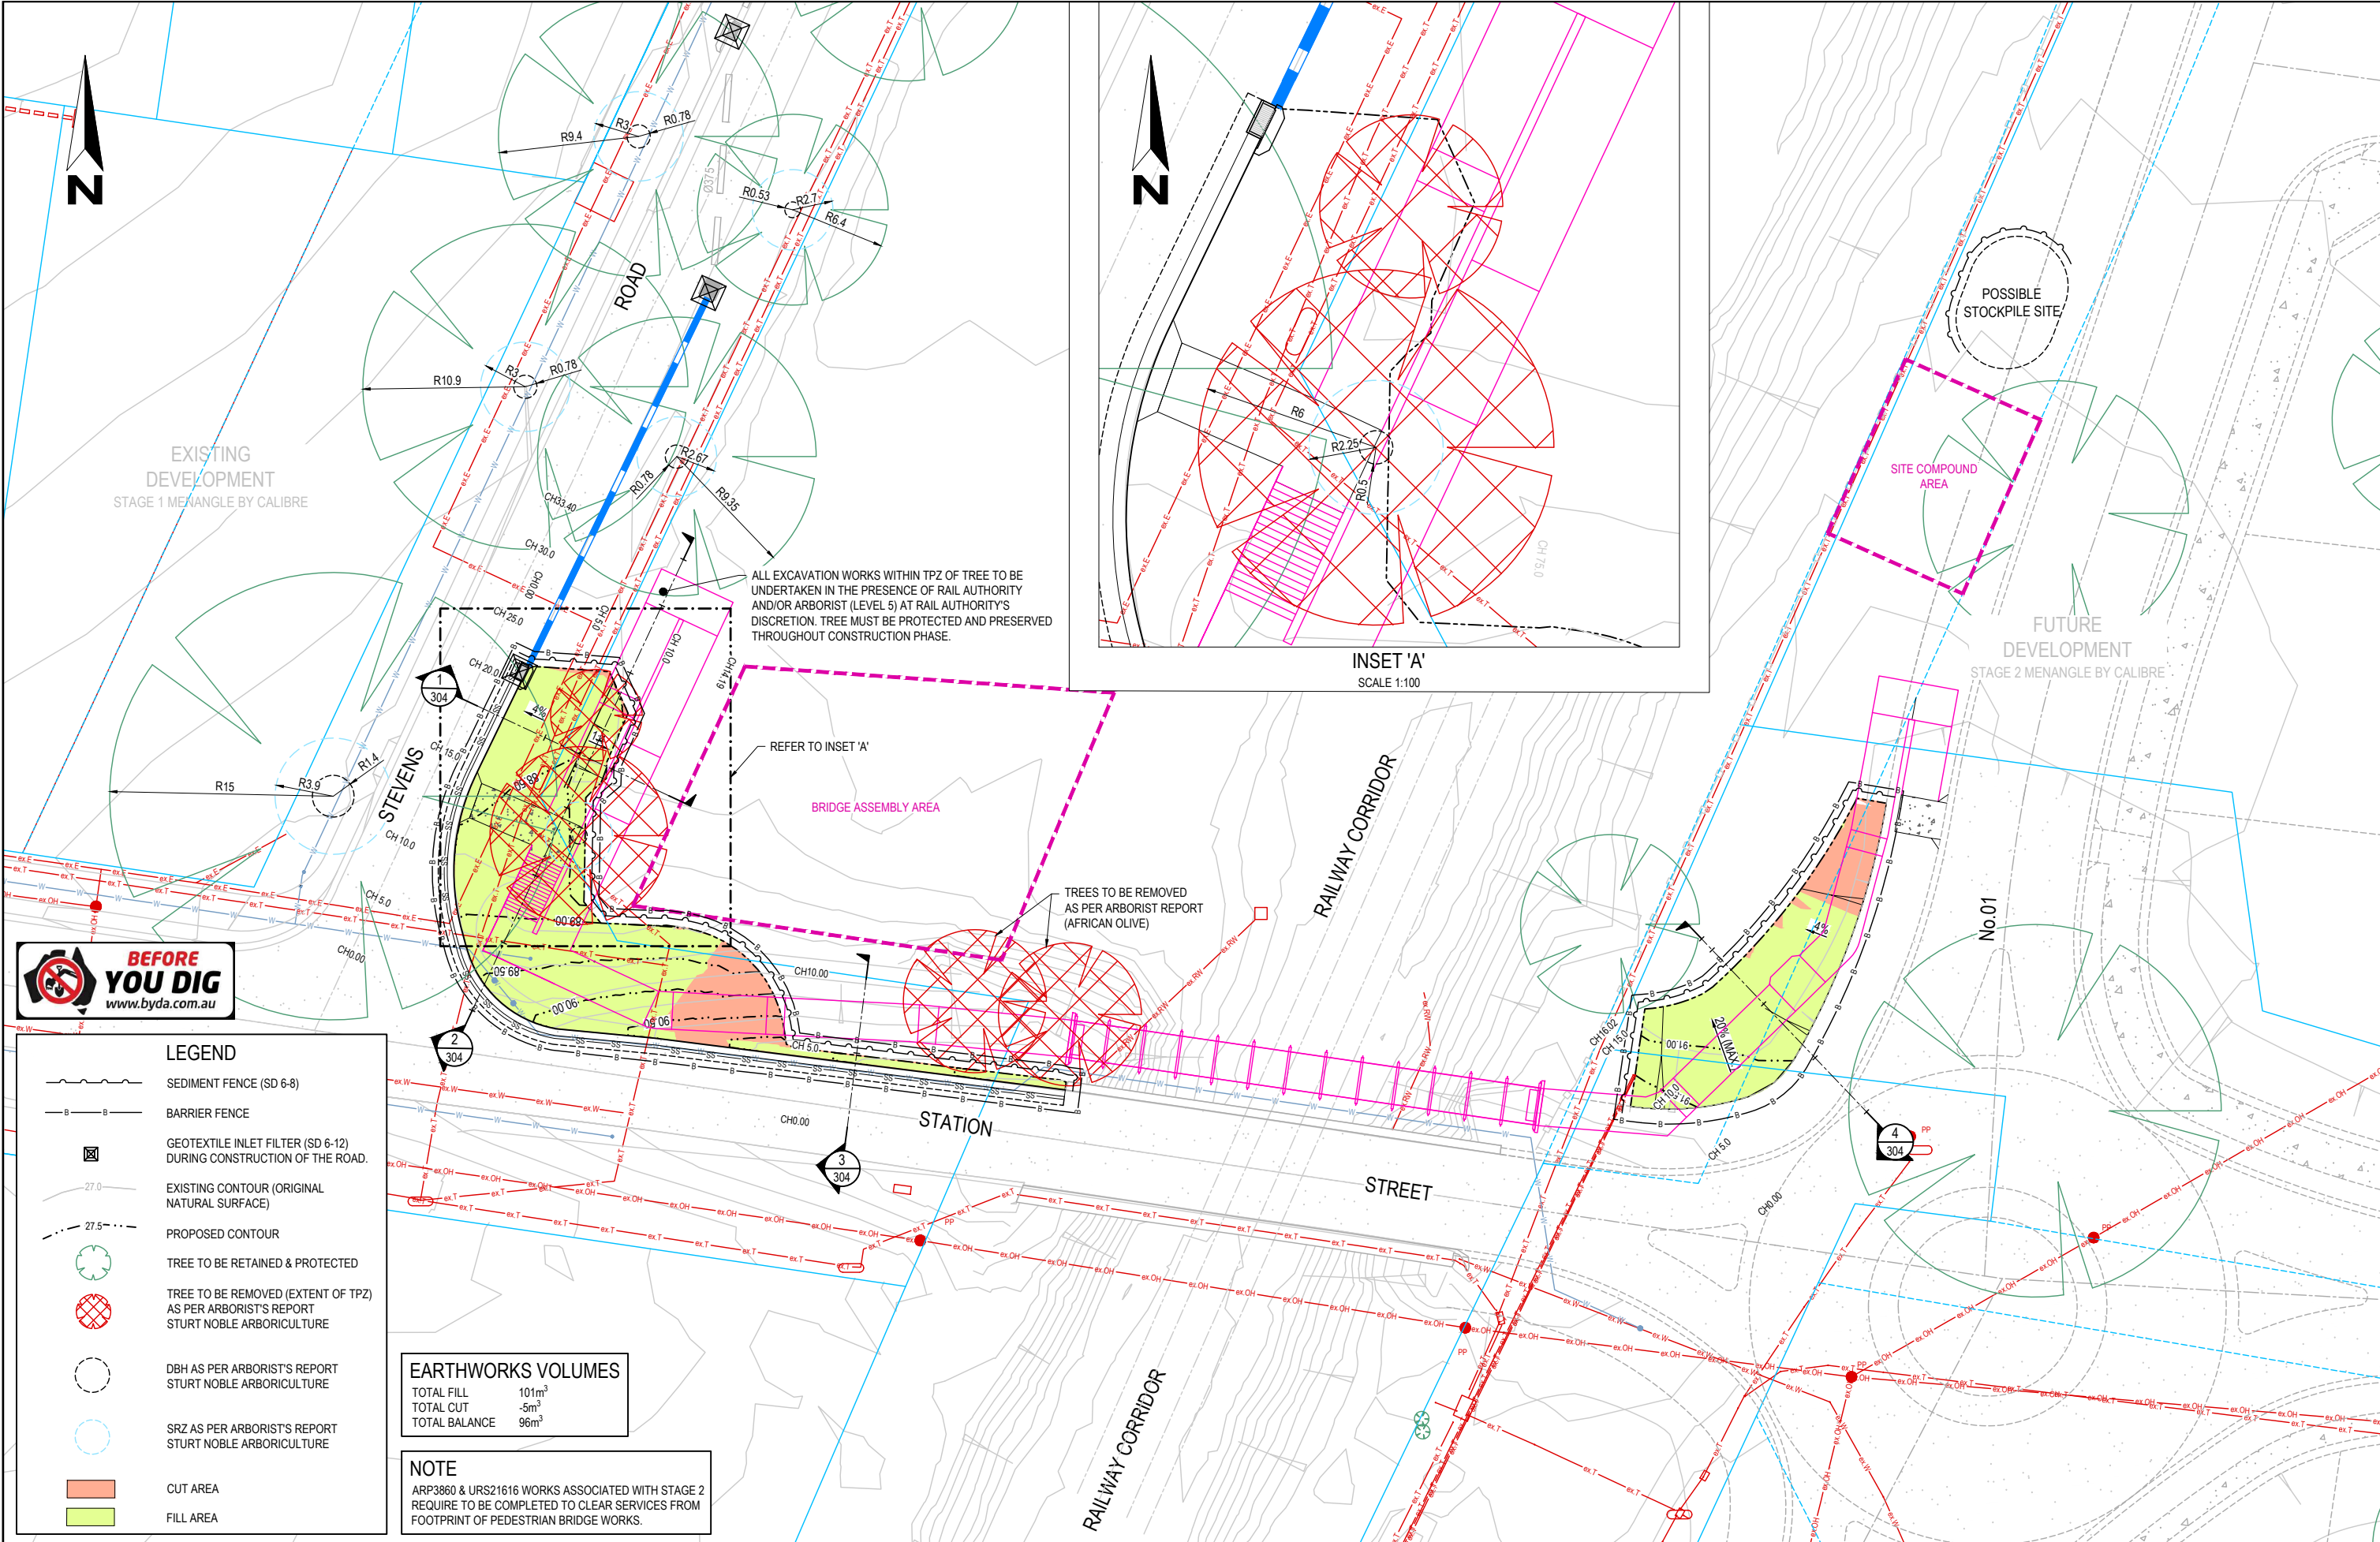

- LEGEND**
- SEDIMENT FENCE (SD 6-8)
 - BARRIER FENCE
 - GEOTEXTILE INLET FILTER (SD 6-12) DURING CONSTRUCTION OF THE ROAD.
 - EXISTING CONTOUR (ORIGINAL NATURAL SURFACE)
 - PROPOSED CONTOUR
 - TREE TO BE RETAINED & PROTECTED
 - TREE TO BE REMOVED (EXTENT OF TPZ) AS PER ARBORIST'S REPORT STURT NOBLE ARBORICULTURE
 - DBH AS PER ARBORIST'S REPORT STURT NOBLE ARBORICULTURE
 - SRZ AS PER ARBORIST'S REPORT STURT NOBLE ARBORICULTURE
 - CUT AREA
 - FILL AREA

EARTHWORKS VOLUMES

TOTAL FILL 101m³
TOTAL CUT -5m³
TOTAL BALANCE 96m³

NOTE


ARP3860 & URS21616 WORKS ASSOCIATED WITH STAGE 2 REQUIRE TO BE COMPLETED TO CLEAR SERVICES FROM FOOTPRINT OF PEDESTRIAN BRIDGE WORKS.

AMENDMENT DETAILS				
FIRST ISSUE	DESIGN	DRAWN	CHECK	APPROD.
01	AV	AB/JS	CK	EF
02	AV	LH	CK	EF
03	AV	AB	CK	EF
04	RT	SS	CK	EF
05	RT	AB	GM	SA

FOR REVIEW OF ENVIRONMENTAL FACTORS (PART 5)

AUTHORISED FOR ISSUE:
BY: SINA ARBABZADEH
MEng (Civil) MIEAust CPEng NER

SIGN: *Sina Arbabzadeh*
DATE: 25/05/2023

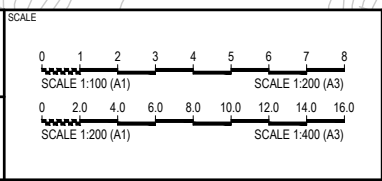

**STATION ST MENANGLE
PEDESTRIAN BRIDGE CROSSING**

DISCLAIMER
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DRAWING TITLE			
SOIL & WATER MANAGEMENT & SITE REGRADING PLAN			
PROJECT No.	DRAWING No.	MILESTONE	REVISION
17-003293.002.PED	101	REF	05

FILE: H1717-2023 - STATION ST MENANGLE - URS21616 WORKS ASSOCIATED WITH STAGE 2 REQUIRE TO BE COMPLETED TO CLEAR SERVICES FROM FOOTPRINT OF PEDESTRIAN BRIDGE WORKS. URS21616 WORKS ASSOCIATED WITH STAGE 2 REQUIRE TO BE COMPLETED TO CLEAR SERVICES FROM FOOTPRINT OF PEDESTRIAN BRIDGE WORKS. URS21616 WORKS ASSOCIATED WITH STAGE 2 REQUIRE TO BE COMPLETED TO CLEAR SERVICES FROM FOOTPRINT OF PEDESTRIAN BRIDGE WORKS.

THE CONTRACTOR SHALL IMPLEMENT ALL SOIL EROSION AND SEDIMENT CONTROL MEASURES IN ACCORDANCE WITH ARTC'S ENVIRONMENTAL PROTECTION LICENCE (SECTION 55 PROTECTION OF THE ENVIRONMENT OPERATIONS ACT 1997) FOR WORKS WITHIN THE RAIL CORRIDOR.

THE CONTRACTOR SHALL IMPLEMENT ALL SOIL EROSION AND SEDIMENT CONTROL MEASURES PRIOR TO THE COMMENCEMENT OF ANY WORKS BEING CARRIED OUT. ALL SOIL AND EROSION MEASURES SHALL BE MAINTAINED AND KEPT IN PLACE FOR THE FULL DURATION OF THE WORKS AND SHALL ONLY BE REMOVED AT FINAL STABILISATION OF THE WORKS. WHERE IT IS NECESSARY TO UNDERTAKE STRIPPING IN ORDER TO CONSTRUCT A SEDIMENT CONTROL DEVICE ONLY SUFFICIENT GROUND SHALL BE STRIPPED TO ALLOW CONSTRUCTION.

ALL SOIL EROSION AND SEDIMENT CONTROL MEASURES SHALL BE CONSTRUCTED & MAINTAINED AS INDICATED ON THESE DRAWINGS AT A MINIMUM LOCATION AND EXTENT OF SOIL & WATER MANAGEMENT DEVICES IS DIAGRAMMATIC ONLY AND THE ACTUAL REQUIREMENTS SHALL BE CONFIRMED ON SITE PRIOR TO COMMENCEMENT.

CONFORMITY WITH THIS PLAN SHALL IN NO WAY REDUCE THE RESPONSIBILITY OF THE CONTRACTOR TO PROTECT AGAINST WATER DAMAGE DURING THE COURSE OF THE CONTRACT. IT SHALL BE THE CONTRACTORS RESPONSIBILITY TO ENSURE THAT ANY NECESSARY CONTROL IS IN PLACE EVEN THOUGH SUCH CONTROL MAY NOT BE SHOWN ON THE PLAN.

THE CONTRACTOR SHALL INFORM ALL SUBCONTRACTORS & ALL EMPLOYEES OF THEIR RESPONSIBILITIES IN MINIMISING THE POTENTIAL FOR SOIL EROSION & POLLUTION TO DOWNSTREAM AREAS

APART FROM SEDIMENT BASINS, THE CONTRACTOR SHALL REGULARLY MAINTAIN SEDIMENT AND EROSION CONTROL STRUCTURES & DESILT SUCH STRUCTURES PRIOR TO THE REDUCTION IN CAPACITY OF 30% DUE TO ACCUMULATED SEDIMENT. THE SEDIMENT SHALL BE DISPOSED OF ON SITE IN A MANNER APPROVED BY THE ENGINEER.

THE CONTRACTOR SHALL TEMPORARILY REHABILITATE WITHIN TEN (10) DAYS ANY DISTURBED AREAS PROVIDING A MINIMUM 60% COVER. FINAL REHABILITATION IS TO BE PROVIDED WITHIN A FURTHER 60 DAYS WITH A MINIMUM 70% COVER.

THE CONTRACTOR SHALL PROVIDE WATERING OF THE VEGETATED BATTERS FOR MAINTENANCE PERIOD. PLANT, MACHINERY AND VEHICLES SHALL NOT BE DRIVEN OVER GRASSED AREAS UNLESS ON AN APPROVED HAULAGE ROUTE.

ALL DRAINAGE WORKS SHOULD BE CONSTRUCTED AND STABILISED AS QUICKLY AS POSSIBLE TO MINIMISE RISK OF EROSION.

SITE ACCESS SHALL BE RESTRICTED TO THE NOMINATED POINTS. THE CONTRACTOR SHALL PROVIDE STABILISED SITE ACCESS.

DUST AND SITE DISTURBANCE MUST BE KEPT TO A MINIMUM. DURING WINDY WEATHER, LARGE, UNPROTECTED AREAS MUST BE KEPT MOIST (NOT WET) BY SPRINKLING WITH WATER TO REDUCE WIND EROSION. ERECT BARRIER FENCING TO MINIMISE LAND DISTURBANCE BY PREVENTING VEHICULAR AND PEDESTRIAN ACCESS TO AREAS BEING REHABILITATED AND LANDS THAT DO NOT NEED TO BE DISTURBED BY THIS PROJECT.


STOCKPILE TOPSOILS, SUBSOILS AND OTHER MATERIALS SEPARATELY.

TOPSOIL SHALL BE STORED IN LOW MOUNDS NO MORE THAN 2 METRES HIGH AND RE-USED WITHIN TWO MONTHS TO MAINTAIN ACTIVE POPULATIONS OF BENEFICIAL SOIL MICROBES & SEED.

PLACE ALL STOCKPILES AT LEAST FIVE METRES FROM AREAS OF LIKELY CONCENTRATED OR HIGH VELOCITY FLOWS, ESPECIALLY EARTH BANKS AND ROADS. IF NECESSARY, EARTH BANKS OR DRAINS WILL BE CONSTRUCTED TO DIVERT LOCALISED RUN-ON.


TURN TOPSOIL STOCKPILES OVER TO AERATE THEM AT MONTHLY INTERVALS. ENSURE VEGETATION IS NOT INCORPORATED INTO THE SOIL

6. AVOID REVERSING THE SOIL PROFILE MATERIALS DURING FILL OPERATIONS - REPLACE DISTURBED SOILS IN THEIR ORIGINAL ORDER.
17. ON COMPLETION OF MAJOR EARTHWORKS AND BEFORE ADDING TOPSOIL, LEAVE DISTURBED LANDS WITH A LOOSE SURFACE. ALTERNATELY, DISTURBED AREAS PREVIOUSLY COMPACTED BY CONSTRUCTION WORKS WILL BE RIPPED TO MORE THAN 200mm ALONG THE CONTOUR BEFORE APPLYING TOPSOIL
18. PROVIDING MATERIALS ARE AVAILABLE, SPREAD TOPSOIL TO A MINIMUM DEPTH OF 75mm IN REVEGETATION AREAS ON SLOPES OF 4(H):1(V) OR LESS AND TO A DEPTH OF 40 TO 60mm IN REVEGETATION AREAS STEEPER THAN 4:1.
19. LEAVE TOPSOIL IN A SCARIFIED OR ROUGH CONDITION ONCE REPLACED TO HELP MOISTURE INFILTRATION AND REDUCE SOIL EROSION.
20. ENSURE SOIL IS THOROUGHLY SOAKED TO A DEPTH OF 75mm (RAIN OR IRRIGATION) IMMEDIATELY BEFORE PLANTING.
21. HANDLE TOPSOIL ONLY WHEN IT IS MOIST (NOT WET OR DRY) TO AVOID DECLINE OF SOIL STRUCTURE
22. THE CONTRACTOR SHALL MAINTAIN A LOG BOOK DETAILING:
 - RECORDS OF ALL RAINFALL
 - CONDITION OF SOIL AND WATER MANAGEMENT STRUCTURES
 - ANY APPLICATION OF FLOCCULATING AGENTS TO SEDIMENT BASIN
 - VOLUMES OF ALL WATER DISCHARGED FROM SEDIMENT BASINS
 - ANY ADDITIONAL REMEDIAL WORKS REQUIRED.
23. THE LOG BOOK SHALL BE MAINTAINED ON A WEEKLY BASIS AND BE MADE AVAILABLE TO ANY AUTHORISED PERSON UPON REQUEST. THE ORIGINAL LOG BOOK SHALL BE ISSUED TO THE PROJECT MANAGER AT THE COMPLETION OF WORKS
24. ALL ROAD EMBANKMENTS TO BE STABILISED AS PER LANDSCAPE ARCHITECTS DETAILS.
25. A SELF AUDITING PROGRAM SHOULD BE ESTABLISHED BASED ON A CHECK SHEET DEVELOPED FOR THE SITE. A SITE INSPECTION USING THE CHECK SHEET SHOULD BE MADE BY THE SITE MANAGER AT LEAST WEEKLY, IMMEDIATELY BEFORE SITE CLOSURE AND IMMEDIATELY FOLLOWING RAINFALL EVENTS THAT CAUSE RUNOFF.
26. UNDERTAKE THE SELF AUDIT BY:
 - WALKING AROUND THE SITE SYSTEMATICALLY (E.G. CLOCKWISE)
 - RECORDING THE CONDITION OF EVERY BMP EMPLOYED
 - RECORDING MAINTENANCE REQUIREMENTS (IF ANY) FOR EACH BMP
 - RECORDING THE SITE WHERE SEDIMENT IS DISPOSED
 - FORWARDING A SIGNED DUPLICATE OF THE COMPLETED CHECK SHEET TO THE PROJECT MANAGER/DEVELOPER/SITE OPERATOR FOR THEIR INFORMATION
27. IN PARTICULAR, INSPECT:
 - LOCATIONS WHERE VEHICLES ENTER AND LEAVE THE SITE
 - ALL INSTALLED EROSION AND SEDIMENT CONTROL MEASURES, ENSURING THEY ARE OPERATING CORRECTLY
 - AREAS THAT MIGHT SHOW WHETHER SEDIMENT OR OTHER POLLUTANTS ARE LEAVING THE SITE OR HAVE POTENTIAL TO DO SO
 - ALL DISCHARGE POINTS, TO ASSESS WHETHER THE EROSION AND SEDIMENT CONTROL MEASURES ARE EFFECTIVE IN PREVENTING IMPACTS TO THE RECEIVING WATERS
28. A SITE INSPECTION USING THE CHECK SHEET WILL BE MADE BY THE SITE MANAGER AT LEAST WEEKLY, IMMEDIATELY BEFORE SITE CLOSURE, AND IMMEDIATELY FOLLOWING RAINFALL EVENTS GREATER THAN 5mm IN 24 HOURS.

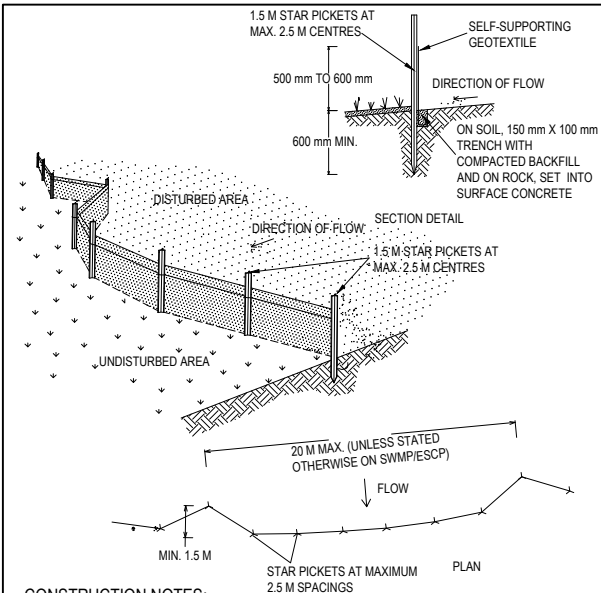


1. CONSTRUCT SEDIMENT FENCES AS CLOSE AS POSSIBLE TO BEING PARALLEL TO THE CONTOURS OF THE SITE, BUT WITH SMALL RETURNS AS SHOWN IN THE DRAWING TO LIMIT THE CATCHMENT AREA OF ANY ONE SECTION. THE CATCHMENT AREA SHOULD BE SMALL ENOUGH TO LIMIT WATER FLOW IF CONCENTRATED AT ONE POINT TO 50 LITRES PER SECOND IN THE DESIGN STORM EVENT, USUALLY THE 10-YEAR EVENT.
2. CUT A 150-mm DEEP TRENCH ALONG THE UPSLOPE LINE OF THE FENCE FOR THE BOTTOM OF THE FABRIC TO BE ENTRENCHED.
3. DRIVE 1.5 METRE LONG STAR PICKETS INTO GROUND AT 2.5 METRE INTERVALS (MAX) AT THE DOWNSLOPE EDGE OF THE TRENCH. ENSURE ANY STAR PICKETS ARE FITTED WITH SAFETY CAPS.
4. FIX SELF-SUPPORTING GEOTEXTILE TO THE UPSLOPE SIDE OF THE POSTS ENSURING IT GOES TO THE BASE OF THE TRENCH. FIX THE GEOTEXTILE WITH WIRE TIES OR AS RECOMMENDED BY THE MANUFACTURER. ONLY USE GEOTEXTILE SPECIFICALLY PRODUCED FOR SEDIMENT FENCING. THE USE OF SHADE CLOTH FOR THIS PURPOSE IS NOT SATISFACTORY.
5. JOIN SECTIONS OF FABRIC AT A SUPPORT POST WITH A 150-mm OVERLAP.
6. BACKFILL THE TRENCH OVER THE BASE OF THE FABRIC AND COMPACT IT THOROUGHLY OVER THE GEOTEXTILE.

SD 6-8

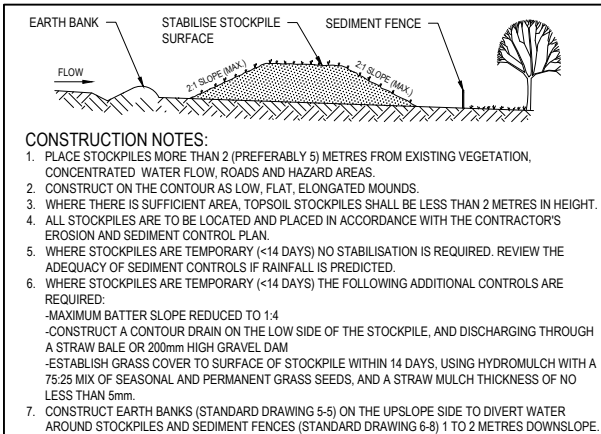




SD 4-1

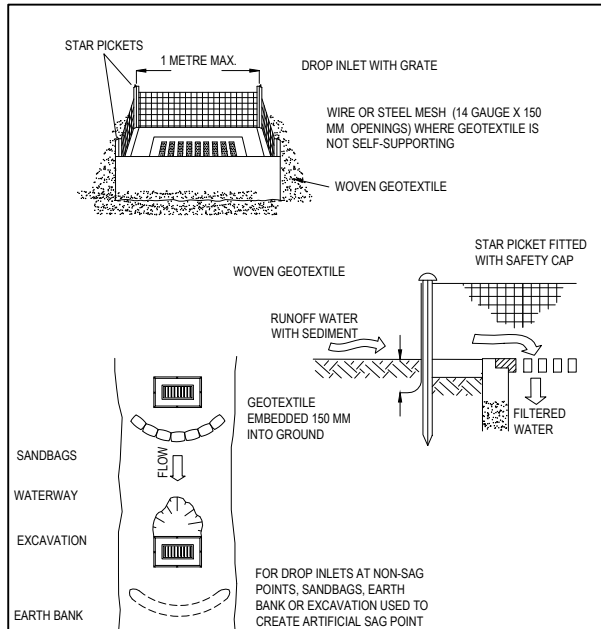

1. FABRICATE A SEDIMENT BARRIER MADE FROM GEOTEXTILE OR STRAW BALES.
2. FOLLOW STANDARD DRAWING 6-7 AND STANDARD DRAWING 6-8 FOR INSTALLATION PROCEDURES FOR THE STRAW BALES OR GEOFABRIC. REDUCE THE PICKET SPACING TO 1 TO 1 METRE CENTRES.
3. IN WATERWAYS, ARTIFICIAL SAG POINTS CAN BE CREATED WITH SANDBAGS OR EARTH BANKS AS SHOWN IN THE DRAWING.
4. DO NOT COVER THE INLET WITH GEOTEXTILE UNLESS THE DESIGN IS ADEQUATE TO ALLOW FOR ALL WATERS TO BYPASS IT.

SD 6-12

[illegible]

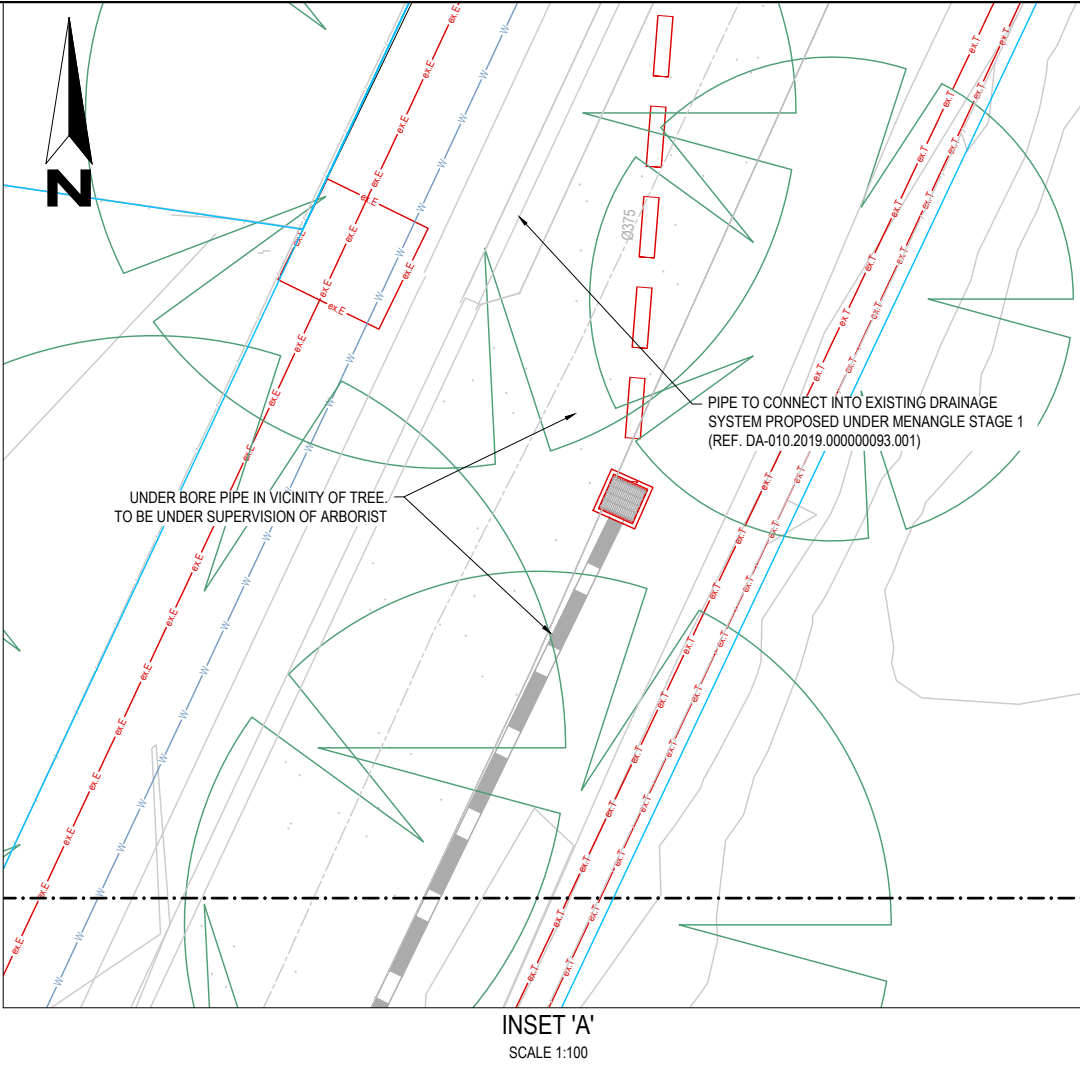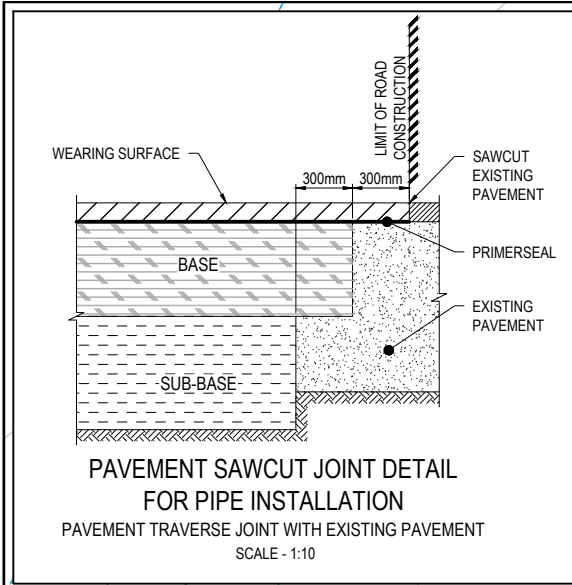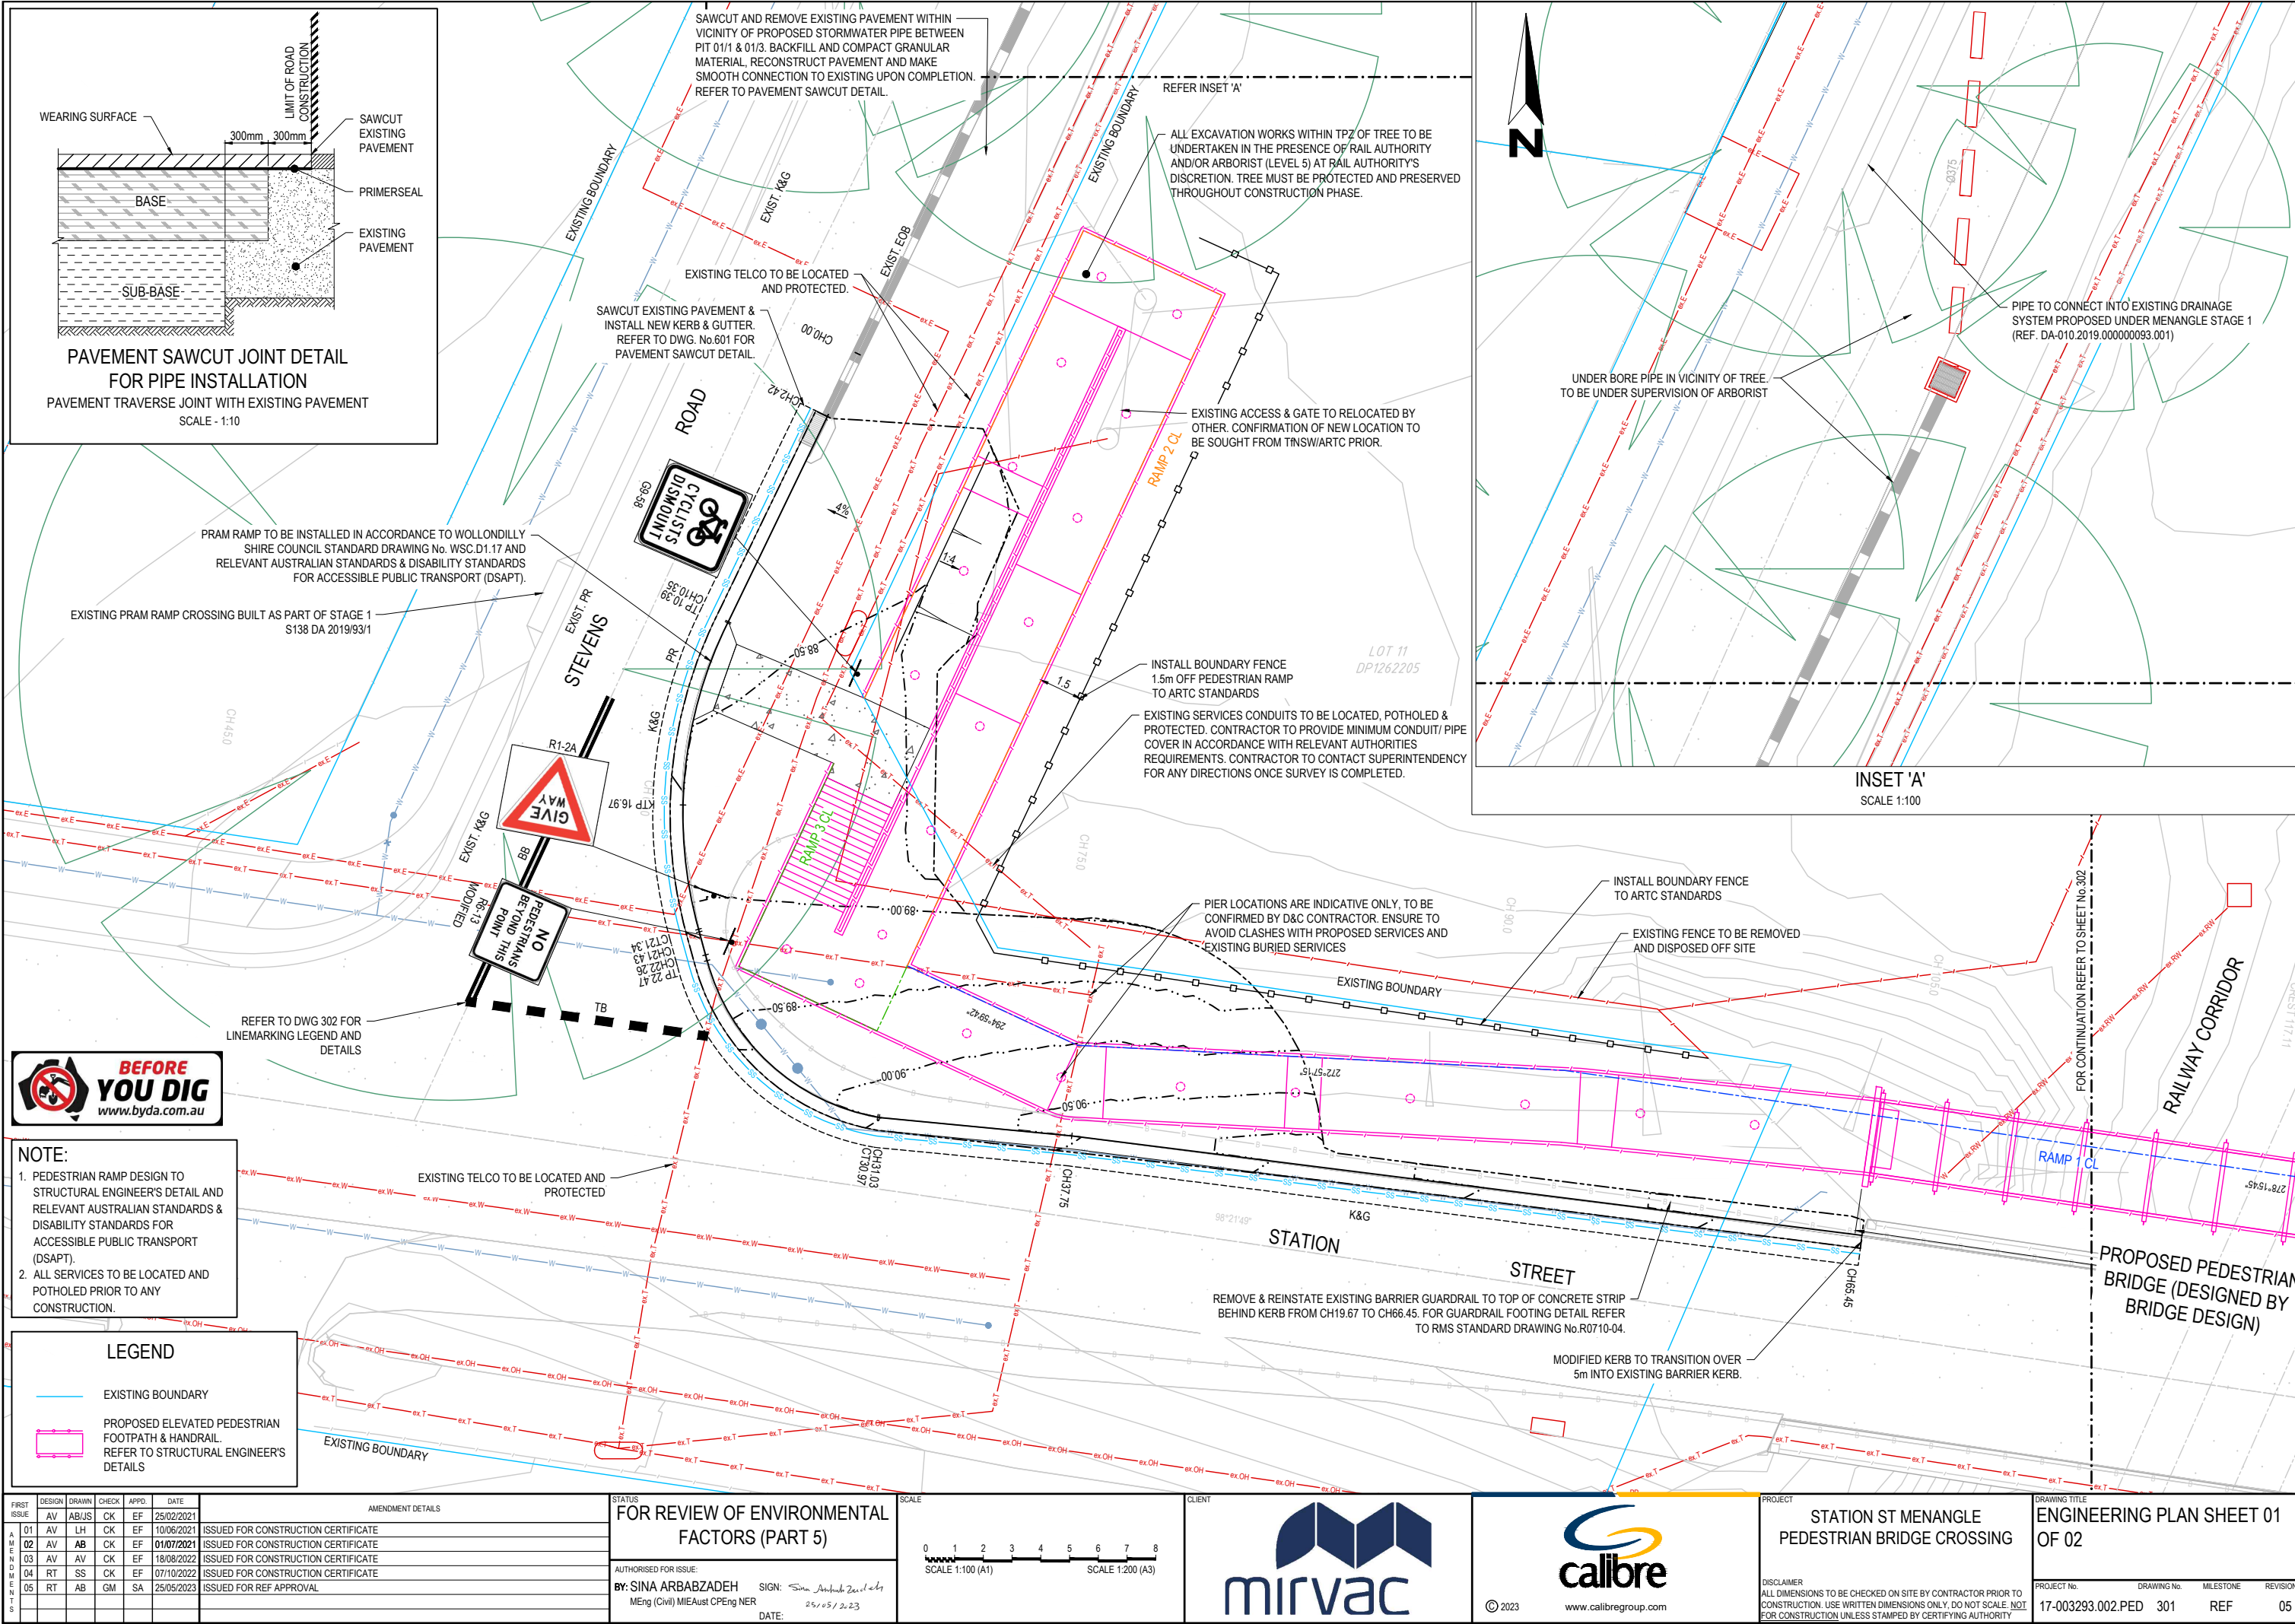

- NOTE:**
1. PEDESTRIAN RAMP DESIGN TO STRUCTURAL ENGINEER'S DETAIL AND RELEVANT AUSTRALIAN STANDARDS & DISABILITY STANDARDS FOR ACCESSIBLE PUBLIC TRANSPORT (DSAPT).
 2. ALL SERVICES TO BE LOCATED AND POTHOLED PRIOR TO ANY CONSTRUCTION.


LEGEND

	EXISTING BOUNDARY
	PROPOSED ELEVATED PEDESTRIAN FOOTPATH & HANDRAIL. REFER TO STRUCTURAL ENGINEER'S DETAILS

ISSUE	DESIGN	DRAWN	CHECK	APPROVED	DATE	AMENDMENT DETAILS
01	AV	AB/JS	CK	EF	25/02/2021	ISSUED FOR CONSTRUCTION CERTIFICATE
02	AV	LH	CK	EF	10/06/2021	ISSUED FOR CONSTRUCTION CERTIFICATE
03	AV	AB	CK	EF	01/07/2021	ISSUED FOR CONSTRUCTION CERTIFICATE
04	AV	AV	CK	EF	18/08/2022	ISSUED FOR CONSTRUCTION CERTIFICATE
05	RT	SS	CK	EF	07/10/2022	ISSUED FOR CONSTRUCTION CERTIFICATE
06	RT	AB	GM	SA	25/05/2023	ISSUED FOR REF APPROVAL

FOR REVIEW OF ENVIRONMENTAL FACTORS (PART 5)

STATUS	FOR REVIEW OF ENVIRONMENTAL FACTORS (PART 5)
AUTHORISED FOR ISSUE:	BY: SINA ARBAZADEH MEng (Civil) MIEAust CPEng NER
SIGN:	Sina Arbazadeh 25/05/2023
DATE:	25/05/2023

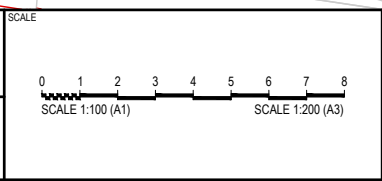


STATION ST MENANGLE PEDESTRIAN BRIDGE CROSSING



PROJECT	STATION ST MENANGLE PEDESTRIAN BRIDGE CROSSING
DISCLAIMER	ALL DIMENSIONS TO BE CHECKED ON SITE BY CONTRACTOR PRIOR TO CONSTRUCTION. USE WRITTEN DIMENSIONS ONLY, DO NOT SCALE. NOT FOR CONSTRUCTION UNLESS STAMPED BY CERTIFYING AUTHORITY.

ENGINEERING PLAN SHEET 01 OF 02

DRAWING TITLE	ENGINEERING PLAN SHEET 01 OF 02
PROJECT No.	17-003293.002.PED
DRAWING No.	301
MILESTONE	REF
REVISION	05

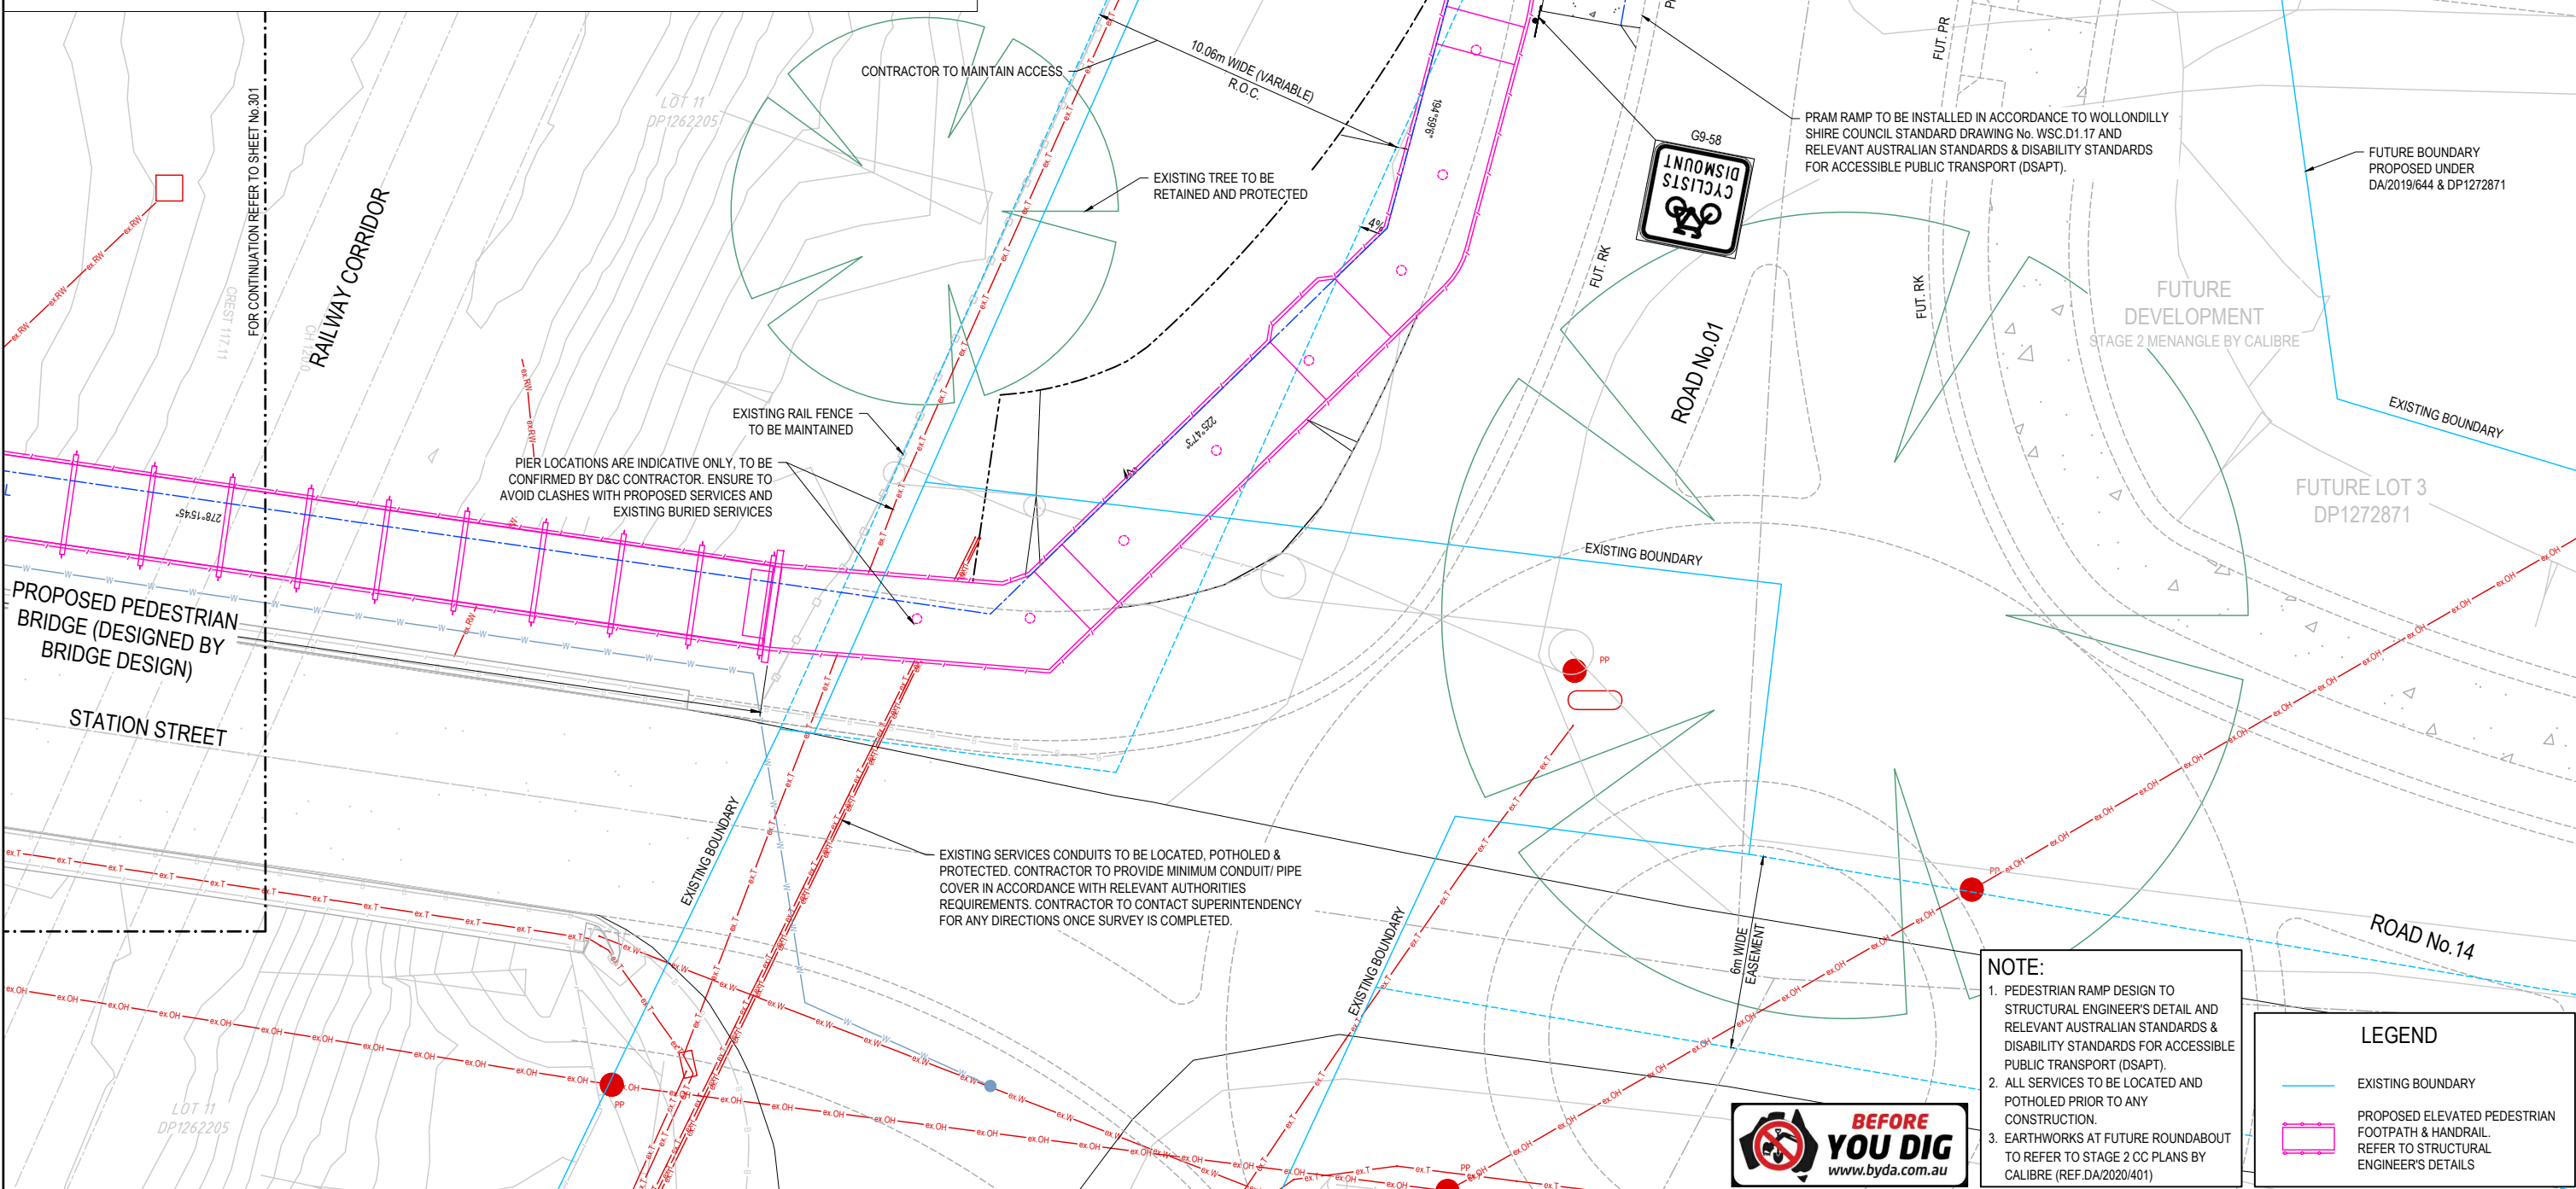LINEMARKING LEGEND						
LINE TYPE	USE	DIMENSIONS (m) (FOR DIMENSIONS SHOWN * SEE MARKER SPACING COLUMN.)	COLOUR	RAISED MARKER TYPE	MARKER SPACING (m)	
					NORMAL SPACING (A)	ALTERNATIVE SPACING (B)
TB	GIVE WAY LINE (USED WITH SIGNS)		WHITE	NOT REQUIRED		
BB	1. REPLACES DIVIDING (SEPARATION) LINE IF RESTRICTED SIGHT DISTANCE FOR BOTH DIRECTIONS OR 2. APPROACH TO MEDIAN ISLAND OR 3. APPROACHES TO A PEDESTRIAN CROSSING		WHITE		12	12



FIRST ISSUE	DESIGN	DRAWN	CHECK	APPD.	DATE											STATUS										SCALE										CLIENT										PROJECT										DRAWING TITLE																																																																																																																																																																																																																																																																																																																																																																																																																																																																																																																																																																																																																																																																																																																																																																																																																																																																																																																																																																																																																																																																																																																																																																																																																																																																																																																																																																																																																																																																																																																																																																																																																																																																																																																																																																																																																																																																																																																																																																																																																																																																																																																																																																																																																																																																																																																																																																																																																																																																																																																																																																																																																																																																																																																																																																																																																																																																																																																																																																																																																																																																																																																																																																																																																																																																																																																																																																																																																																																																																																																																																																																																																																																																																																																																																																																																																																																																																																																																																																																																																																																																																																																																																																																																																																																																																																																																																																																																																																																																																																																		
	AV	AB/JS	CK	EF	25/02/2021											FOR REVIEW OF ENVIRONMENTAL FACTORS (PART 5)										0 1 2 3 4 5 6 7 8 SCALE 1:100 (A1) SCALE 1:200 (A3)																														STATION ST MENANGLE PEDESTRIAN BRIDGE CROSSING										ENGINEERING PLAN SHEET 02 OF 02																																																																																																																																																																																																																																																																																																																																																																																																																																																																																																																																																																																																																																																																																																																																																																																																																																																																																																																																																																																																																																																																																																																																																																																																																																																																																																																																																																																																																																																																																																																																																																																																																																																																																																																																																																																																																																																																																																																																																																																																																																																																																																																																																																																																																																																																																																																																																																																																																																																																																																																																																																																																																																																																																																																																																																																																																																																																																																																																																																																																																																																																																																																																																																																																																																																																																																																																																																																																																																																																																																																																																																																																																																																																																																																																																																																																																																																																																																																																																																																																																																																																																																																																																																																																																																																																																																																																																																																																																																																																																																								
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LEGEND

EXISTING LEVEL





DESIGN LEVEL

STAGE 2 DESIGN LEVEL (AS PER DA 2020/401)

PEDESTRIAN RAMP & BRIDGE. REFER TO STRUCTURAL ENG. DRAWINGS FOR DETAILED BRIDGE DESIGN

CUT AREA

FILL AREA

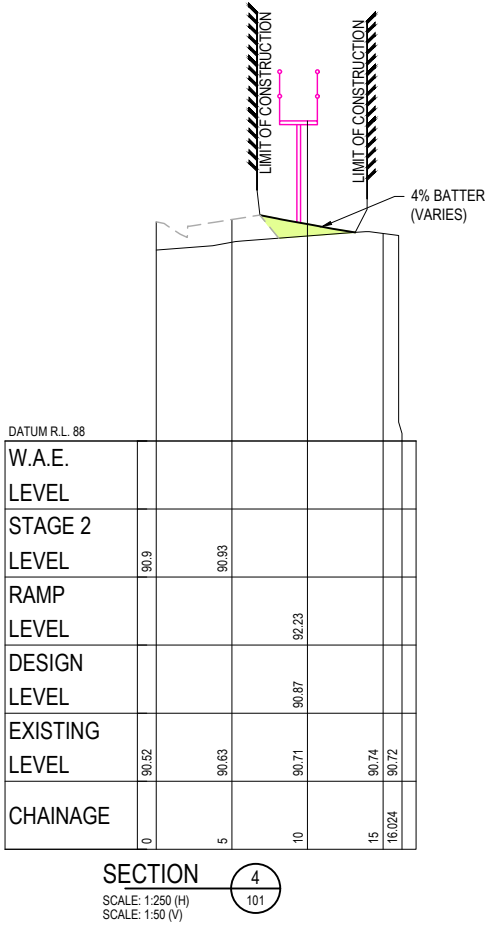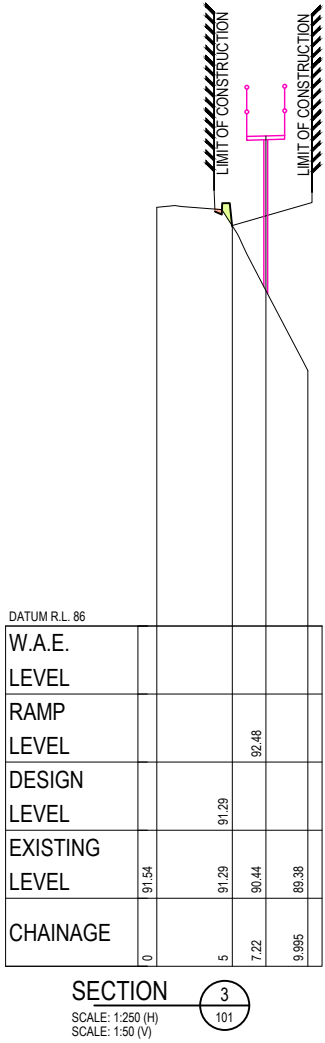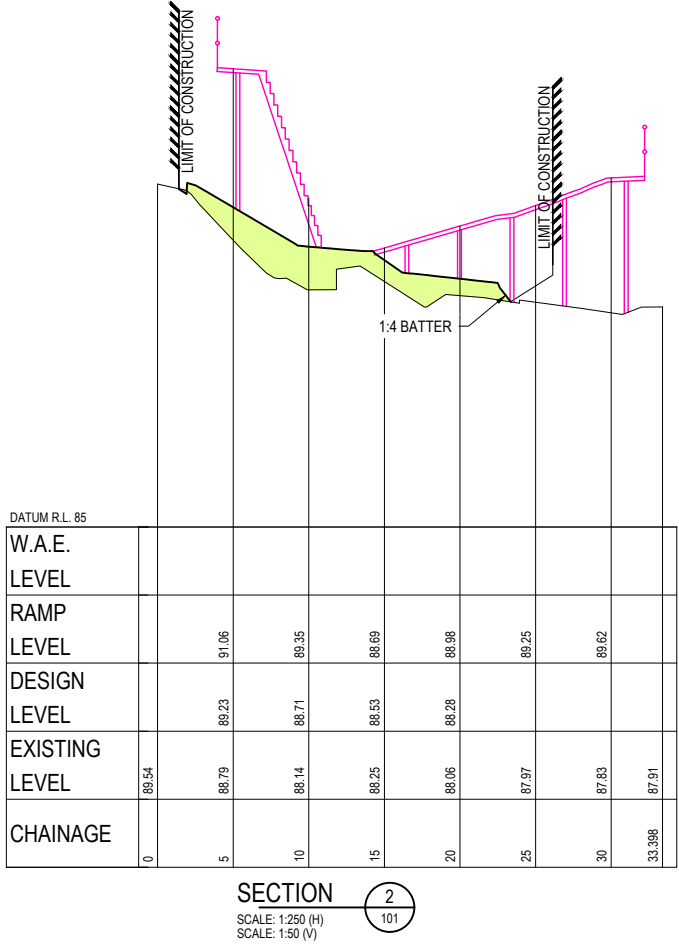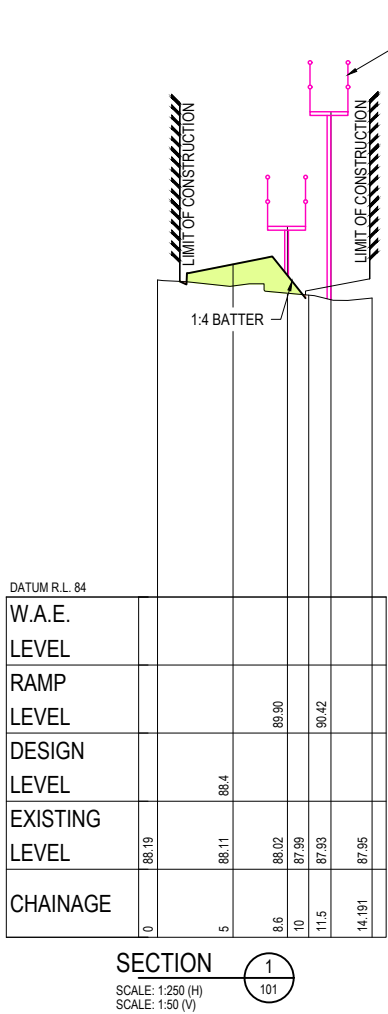

FILE: H:\1717-20203 - STATION ST MENANGLE - U006 - MODEL AUTOCAD\DWG\PEDESTRIAN BRIDGE\SWG17A02293-02.PED_1.D_SWC-303.DWG LAST SAVED BY AIDAN BATH

FIRST ISSUE	DESIGN	DRAWN	CHECK	APPD.	DATE	AMENDMENT DETAILS
01	AV	AB/JS	CK	EF	25/02/2021	
02	AV	LH	CK	EF	10/06/2021	ISSUED FOR CONSTRUCTION CERTIFICATE
03	AV	AB	CK	EF	01/07/2021	ISSUED FOR CONSTRUCTION CERTIFICATE
04	AV	AV	CK	EF	18/08/2022	ISSUED FOR CONSTRUCTION CERTIFICATE
05	RT	SS	CK	EF	07/10/2022	ISSUED FOR CONSTRUCTION CERTIFICATE
06	RT	AB	GM	SA	25/05/2023	ISSUED FOR REF APPROVAL

STATUS


FOR REVIEW OF ENVIRONMENTAL FACTORS (PART 5)

AUTHORISED FOR ISSUE:

BY: SINA ARBAZADEH
MEng (Civil) MIEAust CPEng NER

SIGN: *Sina Arbazadeh*
25/05/2023

DATE:

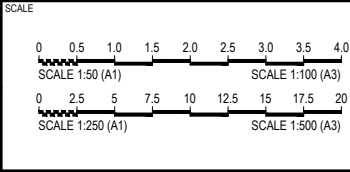



PROJECT

STATION ST MENANGLE
PEDESTRIAN BRIDGE CROSSING

DISCLAIMER
ALL DIMENSIONS TO BE CHECKED ON SITE BY CONTRACTOR PRIOR TO CONSTRUCTION. USE WRITTEN DIMENSIONS ONLY, DO NOT SCALE. NOT FOR CONSTRUCTION UNLESS STAMPED BY CERTIFYING AUTHORITY

DRAWING TITLE			
SITE SECTIONS			
PROJECT No.	DRAWING No.	MILESTONE	REVISION
17-003293.002.PED	303	REF	05

DRAINAGE PIT SETOUT TABLE				
Point	Pit No.	Pit Type	Easting	Northing
1	01/1	G.G.P. 1.2m E.K.I.	284385.037	6213020.977
2	01/2	G.S.I.P. 900x900	291836.509	6221441.770
3	01/3	G.G.P. 1.8m E.K.I.	291833.898	6221449.595

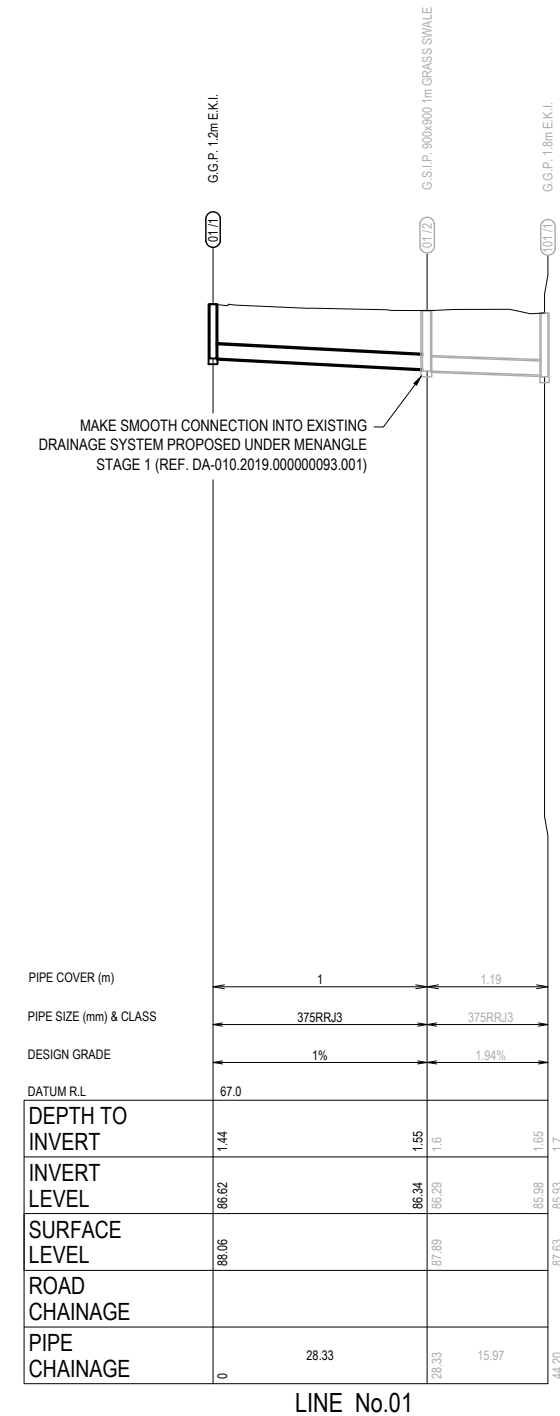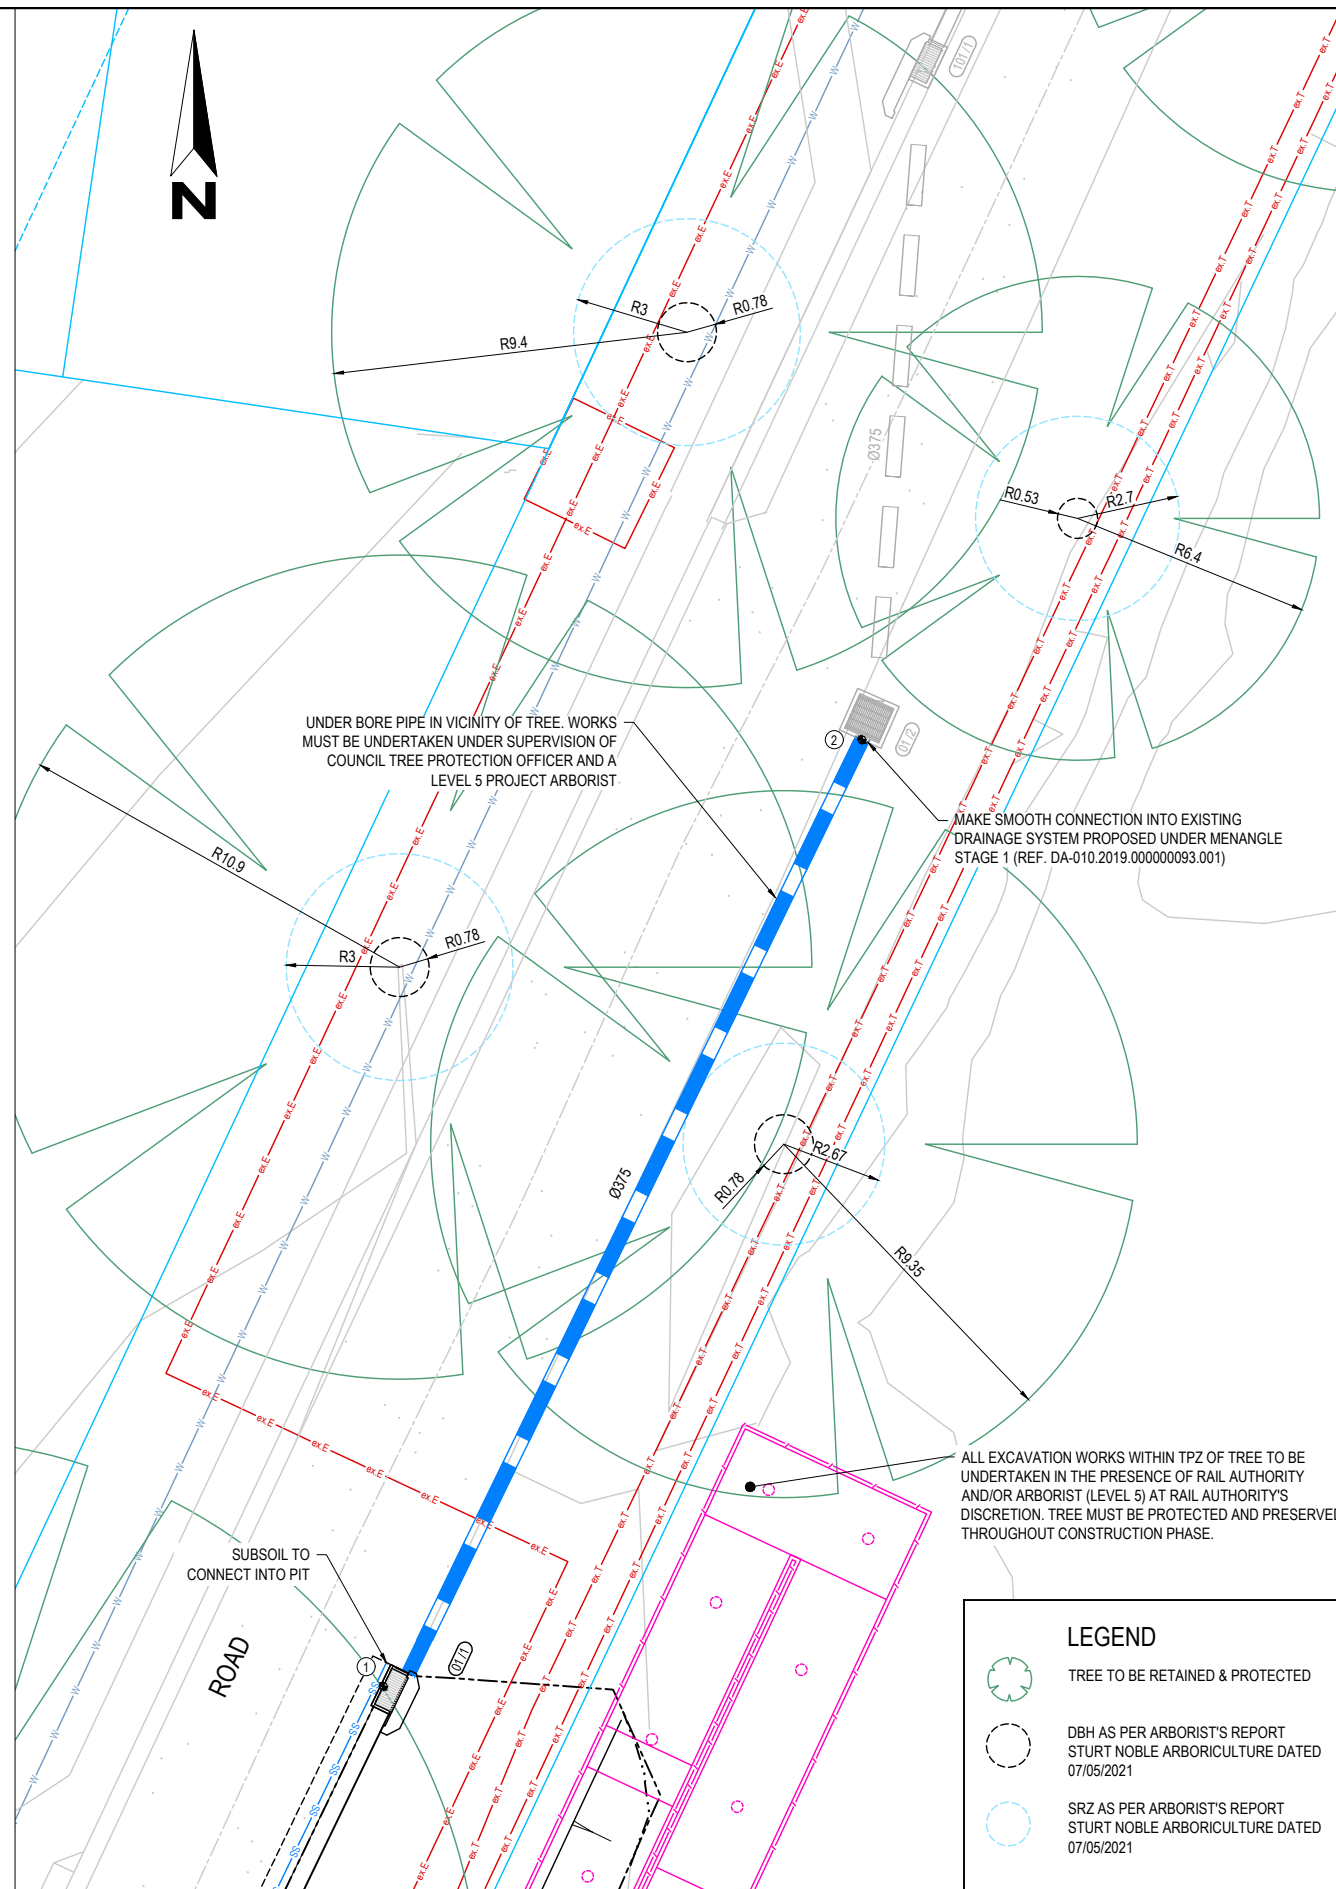


NOTES:

- RRJ3 DENOTES RUBBER RING JOINT CLASS 3 PIPE
- ALL PVC PIPE TO BE CLASS SH.
- PITS TO BE CONCRETE REINFORCED AS PER WOLLONDILLY SHIRE COUNCIL STD DWG STANDARD GRATED KERB INLET PIT WSC.D5.10.
- PITS DEEPER THAN 3.0m, AND GREATER THAN 2.0m IN INTERNAL DIMENSION ARE TO BE STRUCTURALLY DESIGNED.
- CONCRETE 32MPa COMPRESSIVE STRENGTH AT 28 DAYS.

PIT TYPE:

- G.G.P. - GRATED GULLY PIT
- G.S.I.P. - GRATED SURFACE INLET PIT
- J.P. - JUNCTION PIT
- H.W. - HEADWALL
- D.C. - DIRECT CONNECTION
- S.J. - SLOPE JUNCTION
- BEND - BEND IN LINE
- GPT - GROSS POLLUTANT TRAP


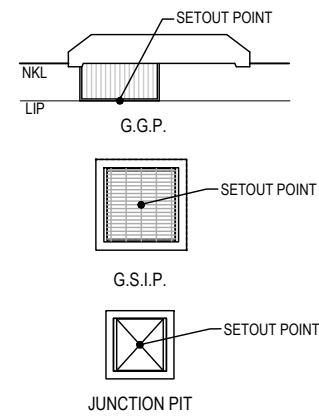


TYPICAL PIT SETOUT DETAIL
N.T.S

DRAINAGE LONGITUDINAL SECTION
SCALE 1:500 (H)
SCALE 1:100 (V)

FILE: H1717-2023 - STATION ST MENANGLE - U006 - MODEL AUTOCAD/PLT/PEDESTRIAN BRIDGE/STATION ST MENANGLE - U006.DWG LAST SAVED BY ADAM BATH

AMENDMENT DETAILS						STATUS		SCALE		CLIENT		PROJECT		DRAWING TITLE	
FIRST	DESIGN	DRAWN	CHECK	APPD.	DATE	FOR REVIEW OF ENVIRONMENTAL FACTORS (PART 5)		0 1 2 3 4 5 6 7 8		mirvac		STATION ST MENANGLE PEDESTRIAN BRIDGE CROSSING		DRAINAGE PLAN	
01	AV	AB/JS	CK	EF	25/02/2021	ISSUED FOR CONSTRUCTION CERTIFICATE		SCALE 1:100 (A1)		calibre		DISCLAIMER		PROJECT No.	
02	AV	AB	CK	EF	10/06/2021	ISSUED FOR CONSTRUCTION CERTIFICATE		0 5 10 15 20 25 30 35 40		www.calibregroup.com		ALL DIMENSIONS TO BE CHECKED ON SITE BY CONTRACTOR PRIOR TO CONSTRUCTION. USE WRITTEN DIMENSIONS ONLY, DO NOT SCALE. NOT FOR CONSTRUCTION UNLESS STAMPED BY CERTIFYING AUTHORITY		DRAWING No.	
03	AV	AV	CK	EF	01/07/2021	ISSUED FOR CONSTRUCTION CERTIFICATE		SCALE 1:500 (A1)		© 2023		MILESTONE		17-003293.002.PED 801	
04	RT	SS	CK	EF	18/08/2022	ISSUED FOR CONSTRUCTION CERTIFICATE		SCALE 1:1000 (A3)		REF		REVISION		05	
05	RT	AB	GM	SA	25/05/2023	ISSUED FOR REF APPROVAL									

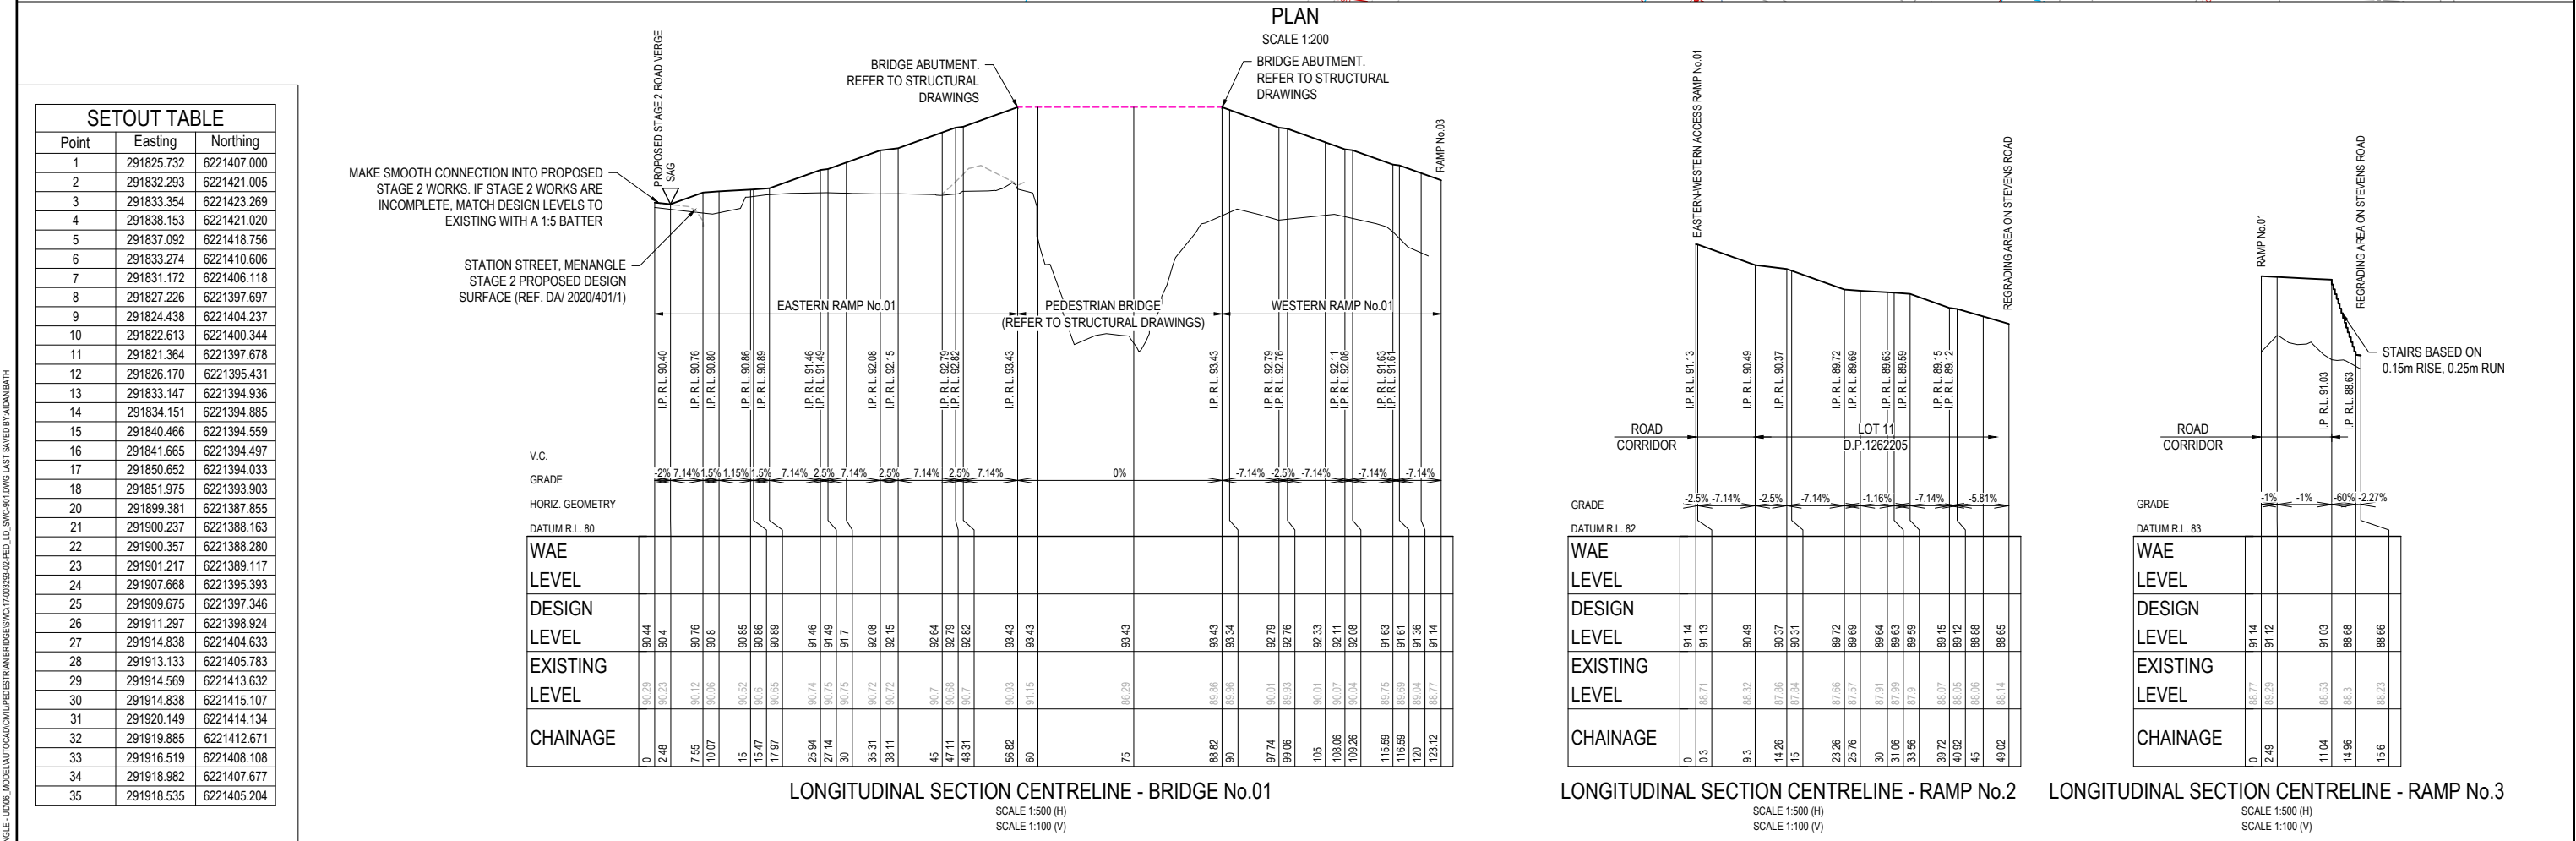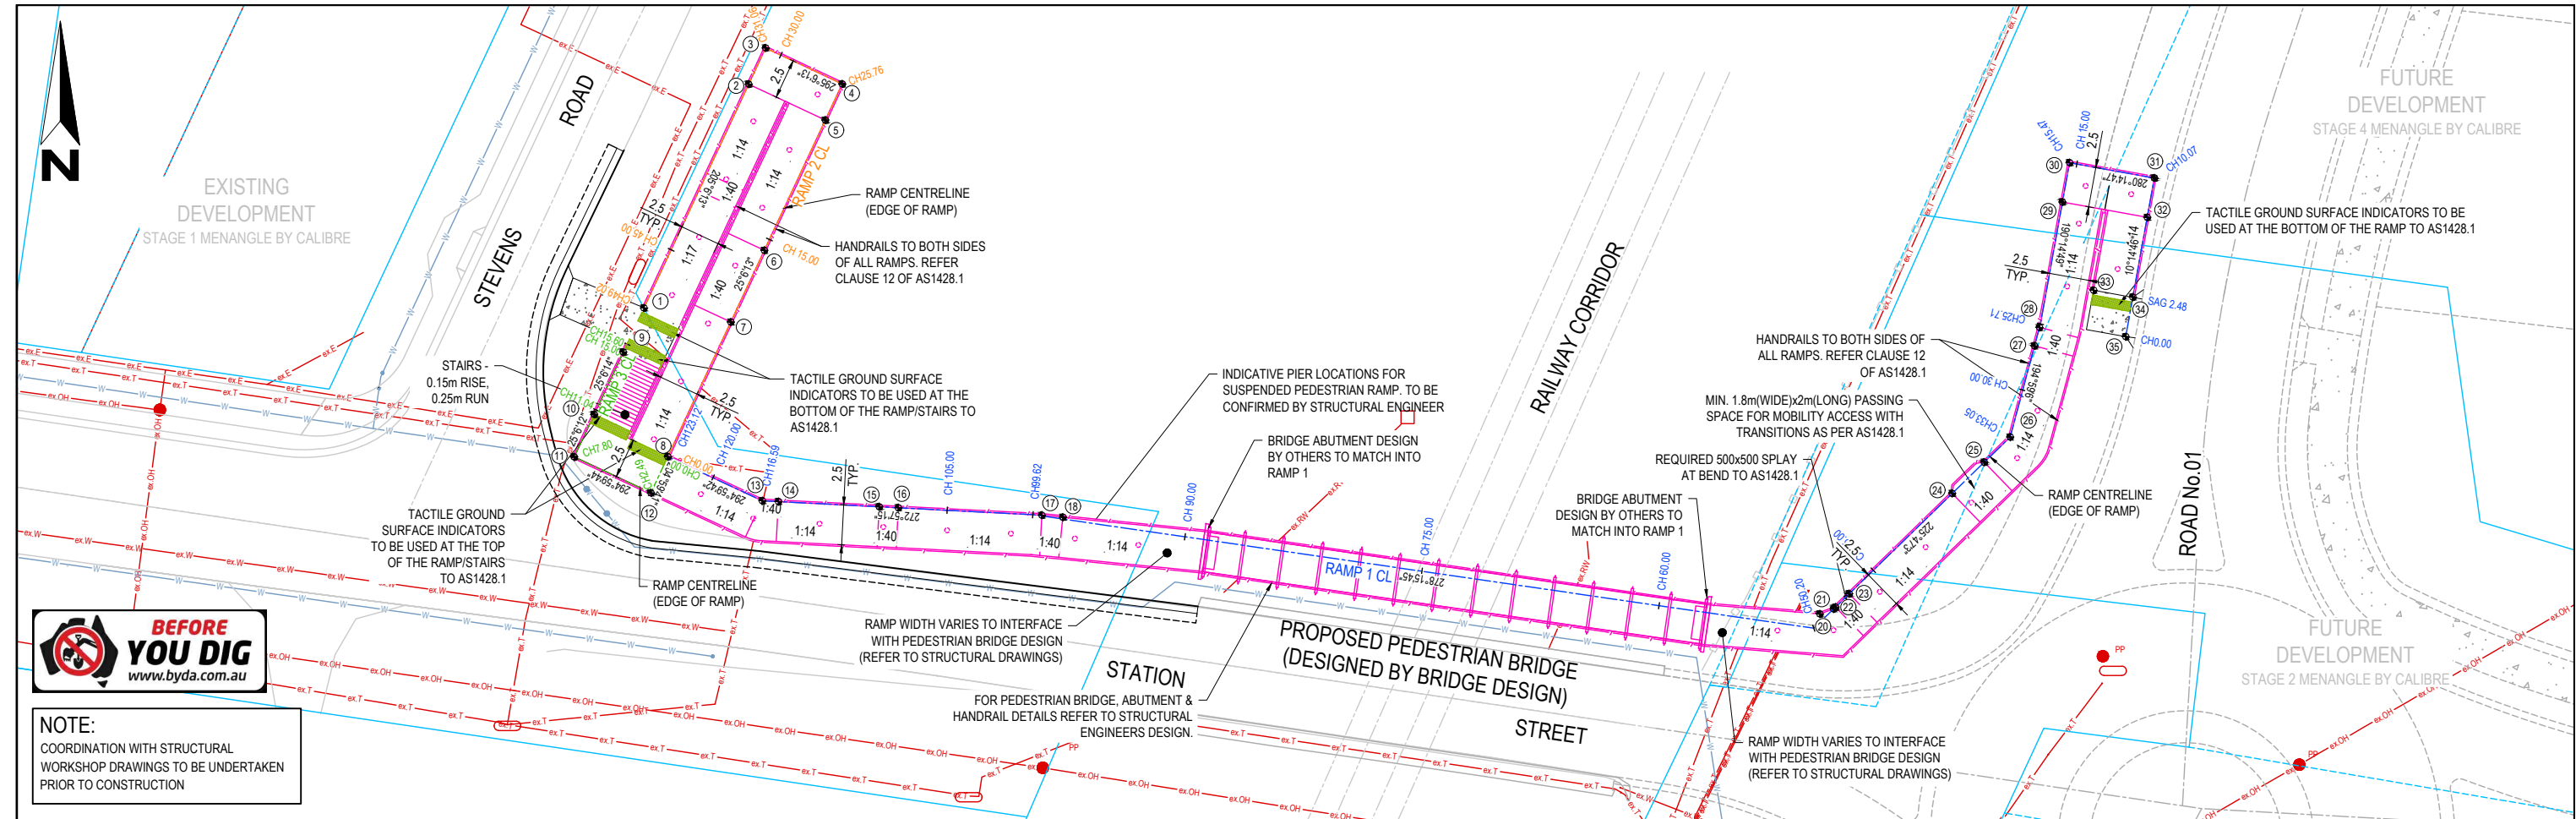

DATE	DESIGN	DRAWN	CHECK	APPD.	DATE	AMENDMENT DETAILS
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STATUS	FOR REVIEW OF ENVIRONMENTAL FACTORS (PART 5)
AUTHORISED FOR ISSUE:	BY: SINA ARBAZADEH MEng (Civil) MIEAust CPEng NER
SIGN:	Sina Arbazadeh 25/05/2023
DATE:	25/05/2023

SCALE	0 2.0 4.0 6.0 8.0 10.0 12.0 14.0 16.0
SCALE 1:200 (A1)	SCALE 1:400 (A3)

CLIENT	
PROJECT	
DRAWING TITLE	STATION ST MENANGLE PEDESTRIAN BRIDGE CROSSING
DISCLAIMER	ALL DIMENSIONS TO BE CHECKED ON SITE BY CONTRACTOR PRIOR TO CONSTRUCTION. USE WRITTEN DIMENSIONS ONLY, DO NOT SCALE. NOT FOR CONSTRUCTION UNLESS STAMPED BY CERTIFYING AUTHORITY.
PROJECT No.	17-003293.002.PED
DRAWING No.	901
MILESTONE	REF
REVISION	05